ADDENDUM No. 2

to Bidding Documents for

TRANSBAY TRANSIT CENTER PROGRAM BUS STORAGE FACILITY CONTRACT NO. 17-05-BSF-000

DATE: February 24, 2017

FROM: Transbay Joint Powers Authority 201 Mission Street, Suite 2100 San Francisco, CA 94105

TO: Prospective Bidders

This Addendum forms a part of the Contract Documents and modifies the original Bidding Documents dated October 31, 2016, with amendments and additions noted below. Acknowledge receipt of this Addendum on the Acknowledgment of Receipt of Addenda form (Section 00 04 32). Failure to do so may subject the Bidder to disqualification.

The Pre-Bid Value Engineering Proposals time frame expired on **Friday**, **February 17, 2017 at 2:00** p.m.

The Questions on Bid Documents time frame expired on Friday, February 17, 2017 at 5:00 p.m.

Bids are due by Wednesday, March 1, 2017 at 2:00 p.m.

This Addendum consists of changes to specifications as noted below and incorporates all the Questions on Bid Documents Responses that were received and answered by the Due Date.

CHANGES TO SPECIFICATIONS

- 1. Section 00 07 00 General Conditions:
 - a. Section 9.04.A is revised to read as follows:

The TJPA shall hold five percent (5%) in retention from each progress payment. The TJPA shall administer retention in conformance with Administrative Code section 6.22J.

b. Section 6.06.C is revised to read as follows:

1. For Work performed by Contractor, the markup shall equal a maximum of 15 percent of its direct costs, as defined herein.

2. For Work performed by a Subcontractor, the markup shall equal a maximum of 15 percent of its direct costs, as defined herein. Contractor shall receive a maximum 5 percent markup on the Subcontractor's total cost.

3. For Work performed by a Lower-Tier Subcontractor or Supplier, the markup shall equal a maximum of 15 percent of its direct costs, as defined herein. Contractor and Subcontractor shall each receive a 5 percent markup on the total cost of their respective Lower-Tier Subcontractors.

4. In no case shall the sum of the individual markups applied to a Change Order exceed 25 percent, regardless of the number of Subcontractor tiers involved in performing the Work.

- 2. Questions on Bid Documents (QBD) Responses:
 - a. The attached IFB Questions and Answers are incorporated into the Bid Documents by this Addendum.

END OF ADDENDUM NO. 2

BUS STORAGE FACILITY (Contract 17-05-BSF-000)

Questions are numbered in the order received.

Question No.	Submission Date	Drawing No.	Document/ Spec. No.	Question	Response
1	1.23.17	1/E-5003		What type of conduit shall be used for the underground duct bank system? On drawing E- 5003, Detail 1 a note says all cable shall be installed in galvanized rigid steel conduit with bushings (This detail is for direct burial conduit in dirt. In specification Section 26 05 43 Underground Ducts and Raceways, paragraph 1.02 Definition A calls for RNC: Rigid Nonmetal Conduit = Type EPC-40-PVC. Please advise what type of conduit you want.	EPC-40-PVC is acceptable per Specification Section 26 05 43 paragraph 2.01. Provide Rigid Steel per Specification Section 26 05 43 paragraph 3.05.1.12, regarding elbows and stub-ups.
2	1.23.17			Can Ameristar be added to the list of acceptable manufacturers?	Ameristar is approved as a vendor for the Guard Booth.
3	1.24.17			The sum listed for performance and payment bonds is \$600,000,000 each. Is this amount correct?	Specification Section 00 07 00, paragraph 10.02.A will be revised to indicate that the Contractor shall purchase and maintain performance and payment bonds valued at "a sum not less than 100 percent of the Contract Sum"
4	1.26.17			The Bidder's Checklist, Spec Section 00 02 00/AT2 mentions that a Certificate of Bidder Regarding Nondiscrimination in Contracts and Benefits should be available in Spec Section 00 04 70. I am unable to locate this section of form.	Specification Section 00 04 70 is attached and will be included in an upcoming addendum.
5	1.27.17			The plans call out a Caltrans approved segmental retaining wall. Is there a particular style and color from Keystone or Versa-Loc, for example that you would like to see on this project?	Contractor is to utilize Calstone CMU color S3147WC for the base color and S359 for the accent color, or an equivalent block and colors. See the attached Excel file for the access color pattern.
6	1.30.17		01 15 90	Where will the field trailers be located?	Field trailers are to be located within the project site boundary lines at a location determined by the Contractor.
7	1.30.17			This section (00 04 70) is listed in the Table of Contents and on the Bidder's Checklist but is missing from the specifications. Please advise.	See response to question 4 above.
8	1.30.17			Please confirm this section (00 04 50) is not due at the time of bid submission from pre-qualified bidders.	Confirmed.

Question No.	Submission Date	5		Question	Response	
9	1.30.17		00 04 10	Bid Form page 00 04 10-3 lists damage rate per day at \$2,500. Bid Form page 00 04 10-5 lists \$3,000 per day. Please advise what the liquidated damages are for the project.	The \$2,500 indicated in Part B of the Bid Form is for bid evaluation of the A+B proposal only and is not intended to match the liquidated damages of \$3,000/day.	
10	1.31.17			Per instructions listed on this form, bidders are to submit a copy of the proof of the SBE/DBE firm listed as well as a signed 'letter of intent'. Please consider changing this requirement so that these forms can be submitted with the post-bid documents (escrow or sub certifications).	provided post-bid.	
11	1.31.17	S-2052 & S-3032		Sheet S-2052 calls out RW #2 as a segmental retaining wall. Detail F on Sheet S-3032 calls out RW #2 as a Caltrans Type 1A. Which is it?	Retaining Wall #2 is to be a Caltrans RW Type 1A, per the details on Sheet S-3032. A revised Sheet S-2052 with a corrected callout is attached and will be issued in an upcoming addendum.	
12	2.1.17	C-2001		Can you tell us what color the colored concrete sidewalk is?	Sidewalk color is to comply with San Francisco Public Works standards.	
13	2.1.17	C-2002, A-1032		There are three maintenance gates shown on the plans at Perry Street. The architectural plans indicate them with note 25, "Not Used". Are we installing gates as shown and if so, what is the style of each of the gates?	See the attached revised Sheet A-1032 for updated gate information.	
14	2.1.17			Regarding the TL4 Crash System, who can I contact for clarification of this scope to submit an accurate bid?	Per Specification Section 00 02 00 paragraph 1.4, Interpretations and Addenda, all questions on the bid documents must be submitted in writing using the QBD form included in Section 00 02 00-AT1.	
15	2.1.17			In regards to Sheets C-1001 and C-1002 titled Existing Condition and Demo plan, it is noted by the legend and shown on the plan views of the subject drawings that the contractor is to remove buried foundations as needed. Should the contractor assume all of the referenced buried foundations are below the elevation of flatwork demo and below the elevation required to install the permanent 12" unreinforced concrete paving and required 8" of base as shown on sheets C-2001 and C-2002, as well as any foundations for permanent structures or walls. Or will the elevations be provided to what depth these foundations have been demolished to?		

Question No.	Submission Date	· · · · · · · · · · · · · · · · · · ·		Response	
				Please note the reference drawings provided have illegible elevations and no information is provided to what elevation the buried foundations have been demolished to.	
16	2.2.17		S-1071	The following are questions related to the above referenced job for the TL4 Crash Barrier Scope: 1. On sheet S-1071 the post spacing as shown for the TL4 system is 5' typical. This system is approved up to a maximum of 8' post spacing. Is it acceptable to supply a TL4 system with 8' post spacing typical and adjusted recess window in concrete barrier to 5'-6" spacing,	 The length of the TL4 system, exclusive of any transition sections, is 170 ft, as shown on Sheet S-1002. 3. Refer to Specification Section 13 48 19, in particular, paragraph 1.03.A, Working Drawings, for the requirements. The rail configuration must meet the contract requirements, as required for Test Level 4, and as determined by the Engineer responsible for the TL4 system. Complete details of the TL4 system are a part of the working drawings. They are not provided in the project plans.

Question No.	Submission Date	Drawing No.	Document/ Spec. No.	Question	Response
17	2.3.17			What style, color, etc. of masonry block is being used for the soundwall? If we are to match an existing sample including grout colors, please provide photographs that we can send to potential masonry subs so that they can bid on an appropriate product.	See response to question 5 above.
18	2.3.17	U-2002		Where is the irrigation backflow preventer located on sheet U-2002?	An upcoming addendum will include a new irrigation backflow preventer, added to Sheet I- 2002, between the existing column and the Storage Building.
19	2.3.17	S-2024		On sheet S-2024, it seems to indicate that the CMU around the storage building does not have soundproof cladding. The reference Detail C/S- 3000 shows that the CMU wall does get soundproof cladding. Is this section wall soundproofed?	
20	2.3.17	C-2301		Can you identify all of the bridge columns that get protection as shown in Detail 6 on sheet C- 2301?	Contractor is to utilize column protection as shown in Detail 6 on Sheet C-2301 for the following columns: three large columns at the entrance to the facility located along Bent Line 8 and all median island columns located along Bent Line 9.

SECTION 00 04 70 – CERTIFICATE OF BIDDER REGARDING NONDISCRIMINATION IN CONTRACTS AND BENEFITS

Bidder, by signing and submitting the attached Bid Form, hereby acknowledges that Bidder has read and will comply with chapter 12 B "Nondiscrimination in Contracts" of the San Francisco Administrative Code and attests to the following (please check the applicable box):

- The San Francisco Human Rights Commission (HRC) has certified that Bidder is in compliance with chapter 12B of the San Francisco Administrative Code, and all applicable related requirements as specified in the Contract Documents, and the certification is in effect on the date of Bid opening. A copy of the Bidder's certification is attached.
- Bidder has submitted Form HRC-12B-101, Form HRC-12B-102, or Form HRC-12B-103 and all required documentation to the HRC seeking certification of compliance with chapter 12B, and determination of compliance is pending review by the HRC. Bidder agrees to resolve all noncompliance through conciliation with HRC as a condition precedent to award of the Contract. If the HRC determines that Bidder is noncompliant, Bidder's Bid shall be deemed nonresponsive. A copy of the Bidder's application form is attached.
- Bidder acknowledges that full compliance with chapter 12B of the San Francisco Administrative Code is a condition precedent for award of the Contract, and if determined to be the low Bidder, Bidder will submit Form HRC-12B-101, Form HRC-12B-102, or Form HRC-12B-103 and all required documentation to the HRC within 10 working days after the date of Bid opening. If the HRC determines that Bidder is non-compliant, Bidder's Bid shall be deemed non-responsive.

Bidder's Name	Signature of Bidder/Authorized Representative				
	8				
Name and Title of Signer	Date				
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Bidder's Street Address					
Didder 5 Street Address					
Bidder's City, State, ZIP					

Bidder's Telephone No.

Note: The text of chapter 12B of the San Francisco Administrative Code is available online at http://sfgov.org/cmd/sites/default/files/Documents/chap12b.pdf.


HRC forms and Quick Reference Guide are available on the TJPA website: http://transbaycenter.org/uploads/ 2009/10/HRC-12B-Fact-Sheet.pdf. For questions regarding 12B compliance, contact the HRC, 25 Van Ness Avenue, Suite 800, San Francisco 94102-6033, telephone (415) 252-2500, http://sf-hrc.org/. Bidders seeking certification are advised to submit HRC forms and accompanying documentation to the HRC at the earliest possible opportunity.

END OF SECTION 00 04 70

SPECIFICATION LOG


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A	October 31, 2016		

Bus Storage Facility

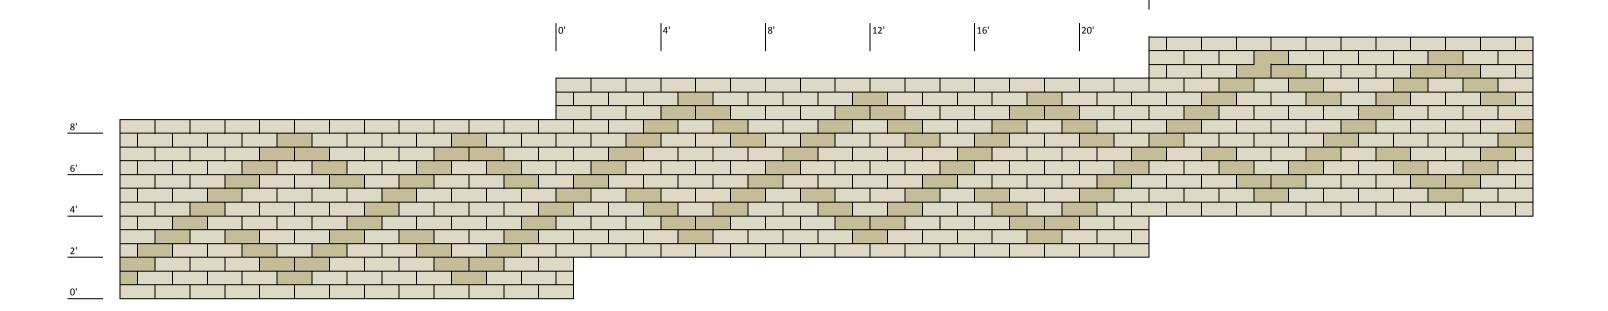


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QBD #5

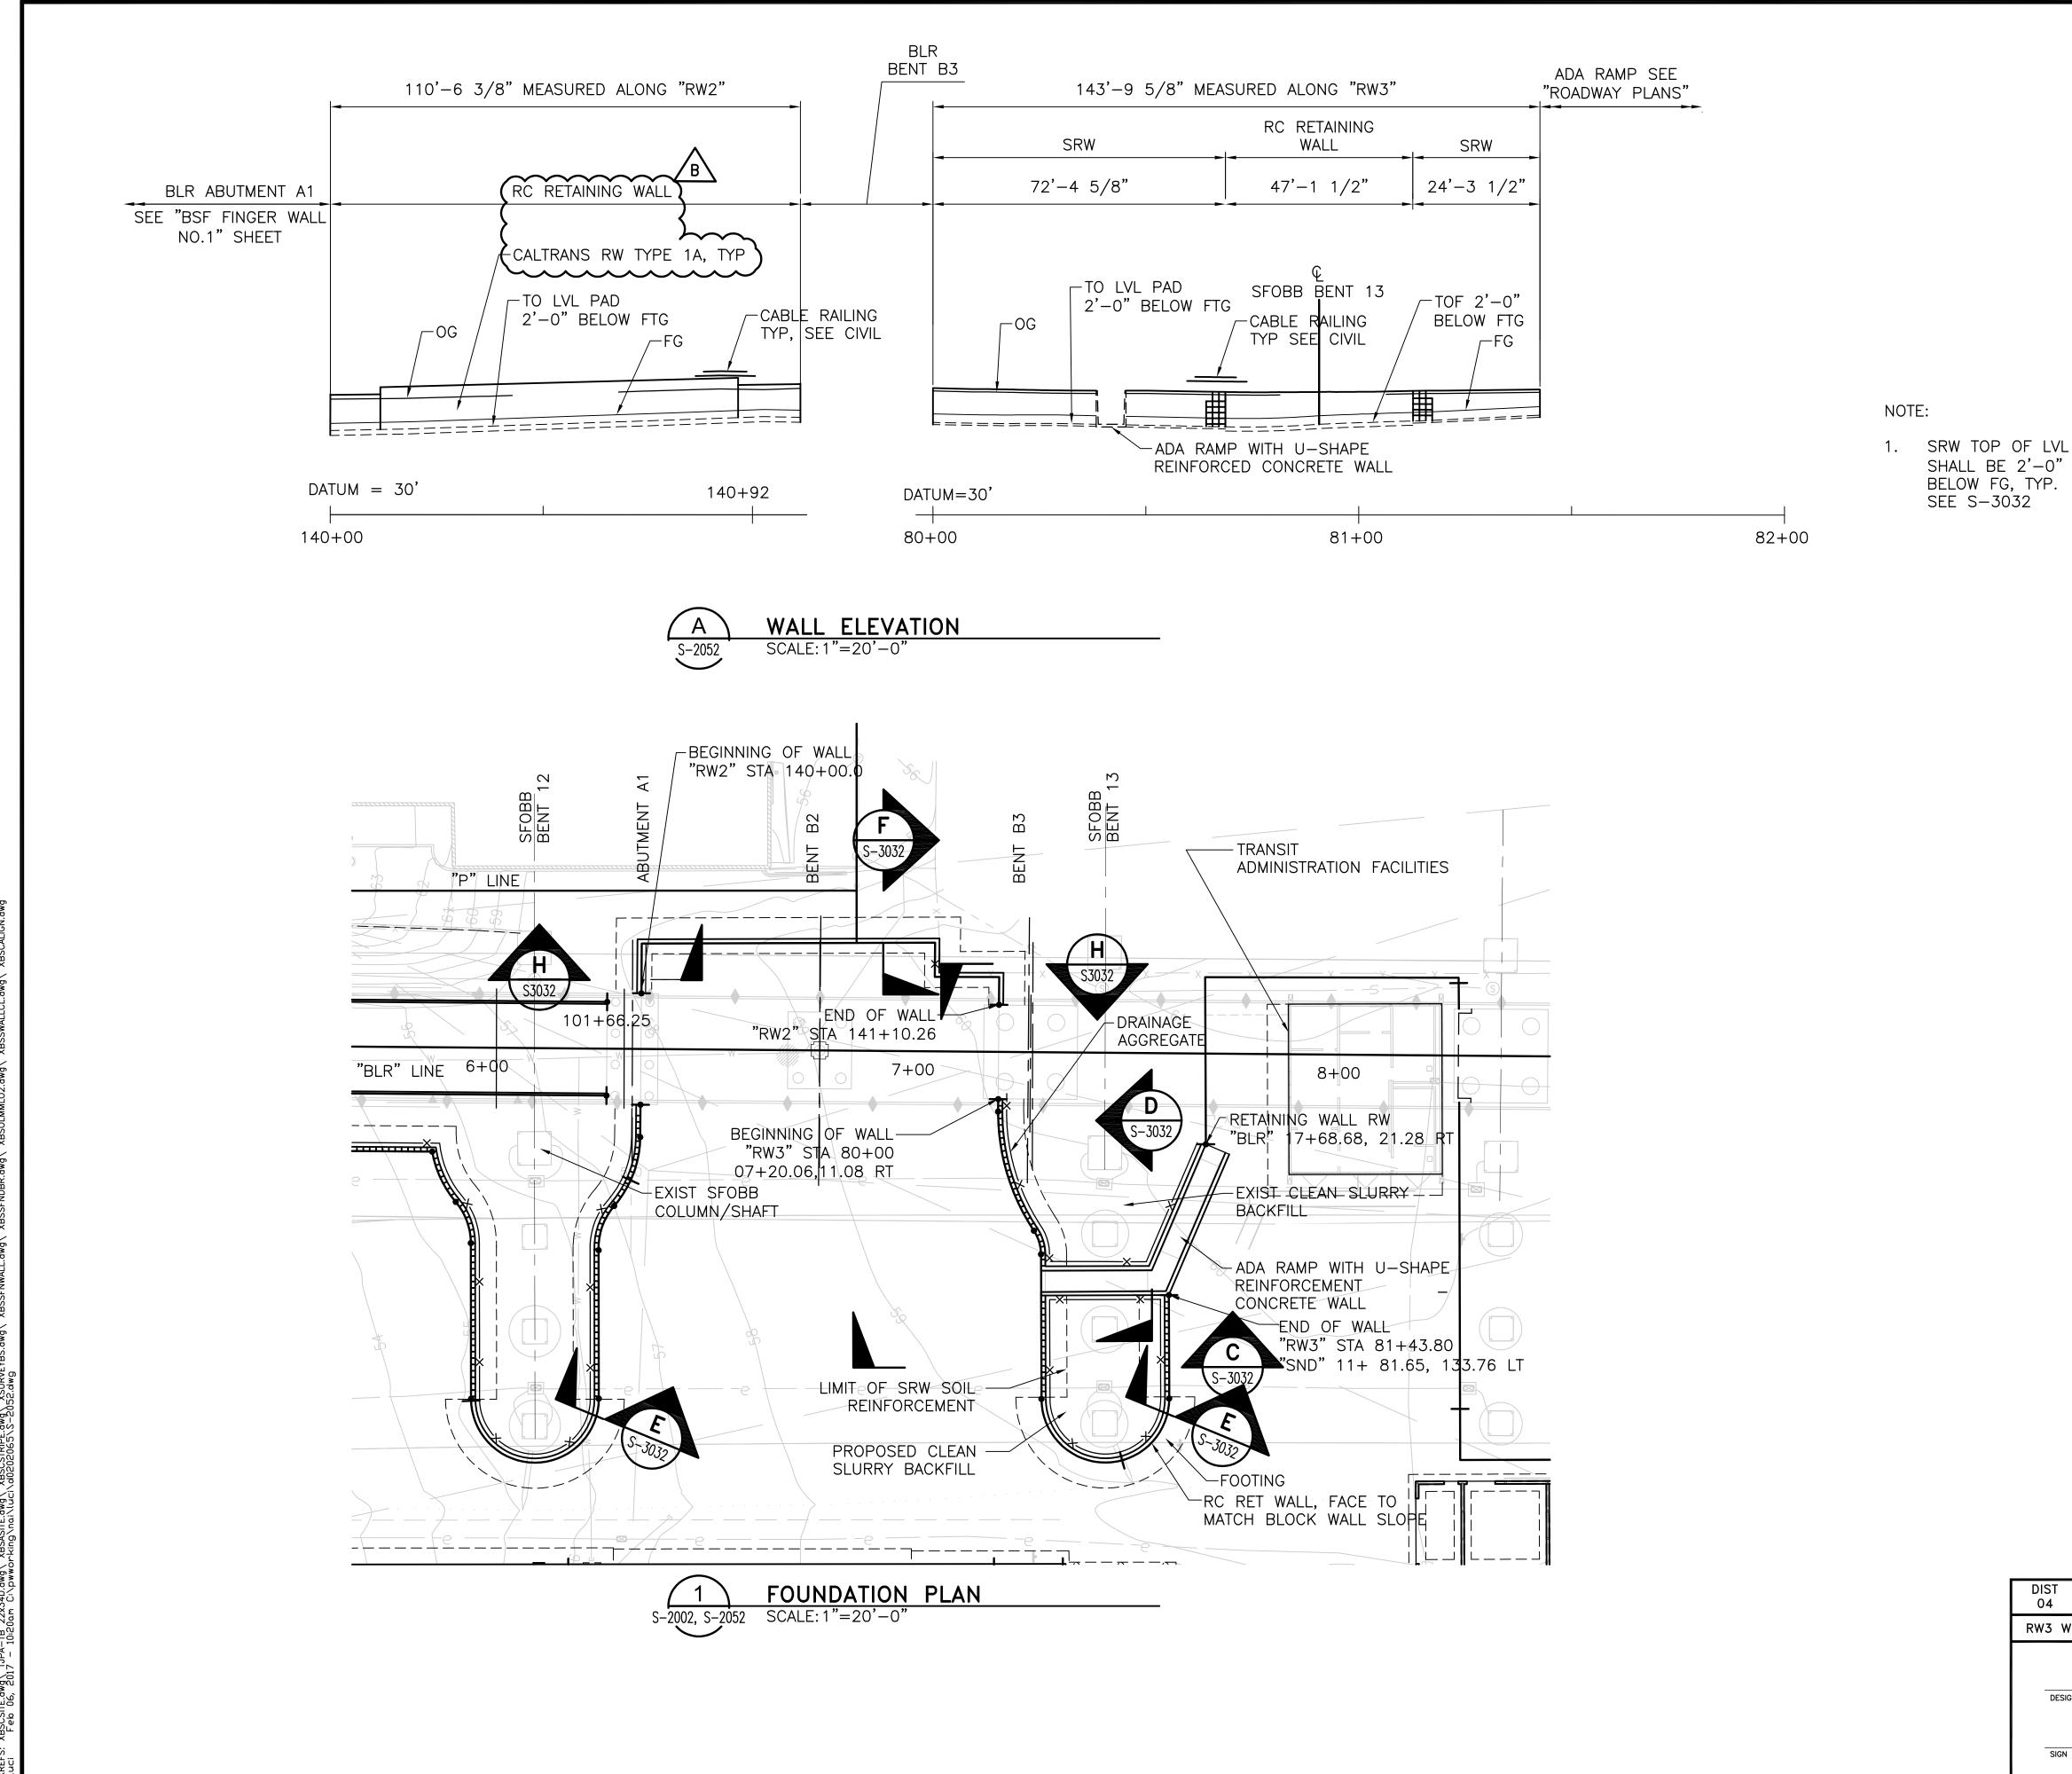


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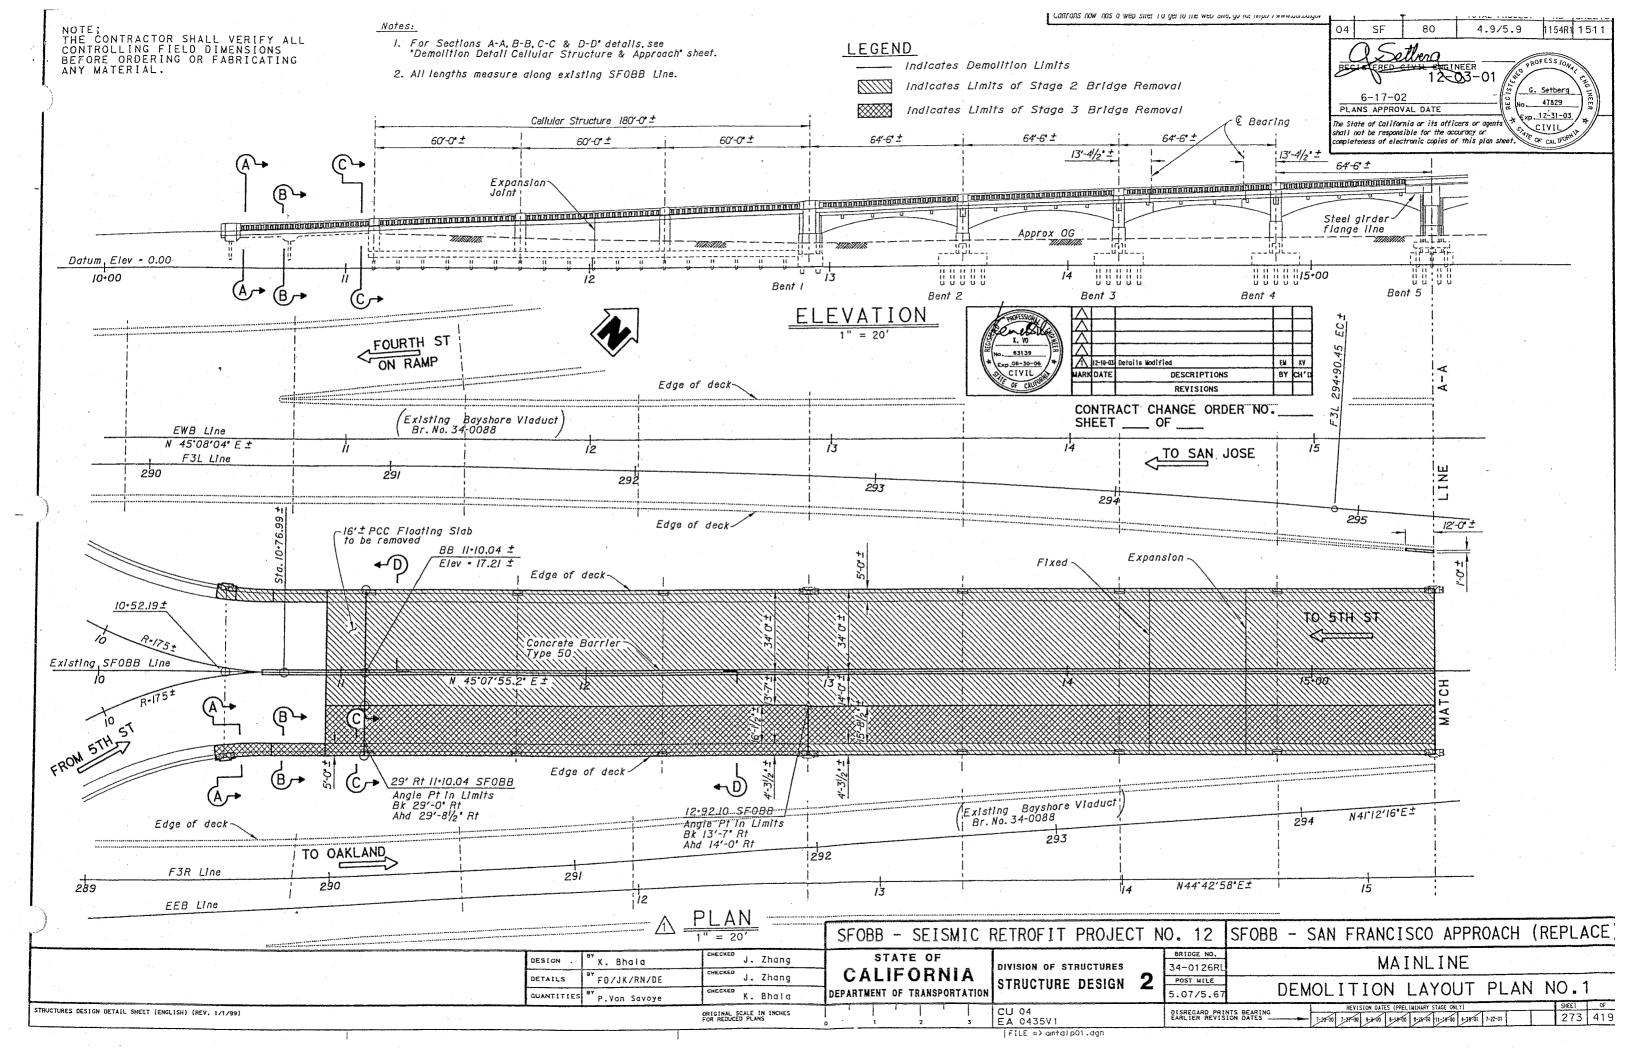
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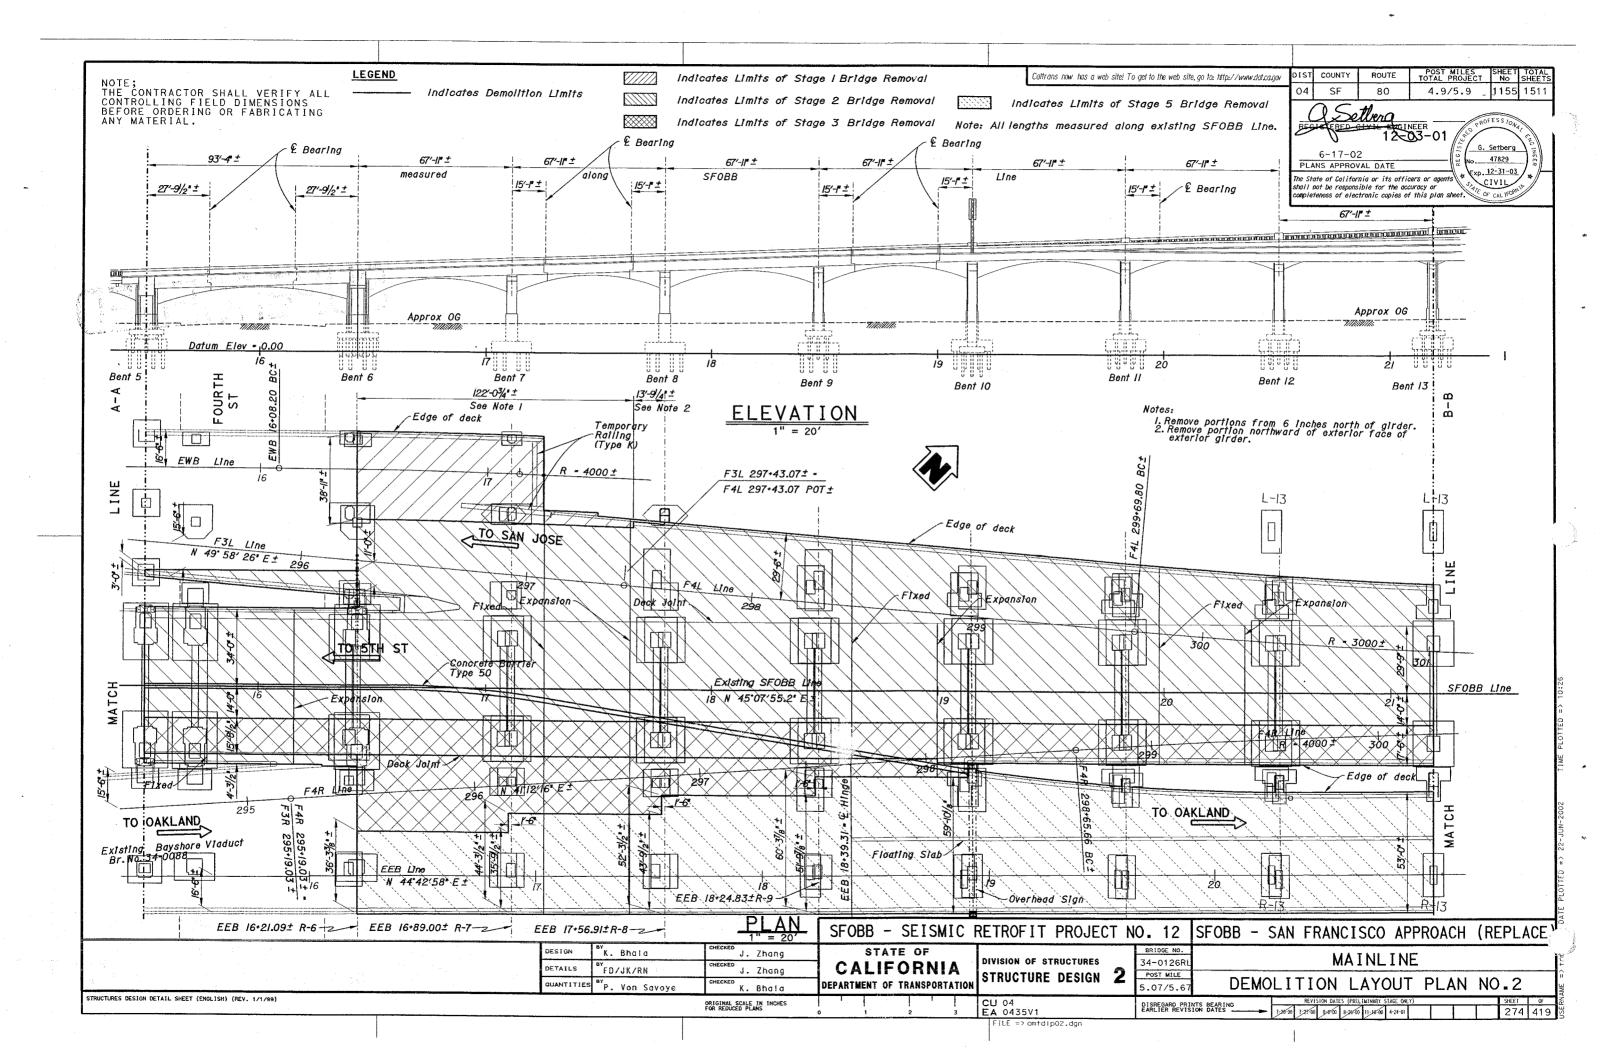



KEY NOTES: (1) EXISTING SIDE WALK AND GUTTER.							
2 CMU BLOCK WALL WITH SOUND ATTENUATION PANELS. SEE A-8001 AND STRUCTURAL DRAWINGS FOR LOCATIONS.			BAY			Transit S AUTH	
3 BUS LINK RAMP, SEE CIVIL AND STRUCTURAL DRAWINGS.			A		\bigcirc	3	
4 CONCRETE CURB, SEE CIVIL DRAWINGS.	300) FR	OA	H. OGAN KLAND, NE: 510	CA 94		TE 10
5 CONCRETE CURB & GUTTER. SEE CIVIL DRAWINGS.				T		SAMANCECO SFRAT	and and a start of the start of
6 EXISTING EDGE OF UPPER BAY BRIDGE APPROACH.				M MESS AVE	MARKE S	10 ¹ 5 ¹ 0 ¹	STO UN
7 EXISTING EDGE OF LOWER BAY BRIDGE APPROACH.	PRC	JECT			S ANRES	THE EMBARCADERO	
8 STRIPING ON AC PAVING. SEE CIVIL DRAWINGS.				Key	Мар	THE	N
9 WHEELSTOP, SEE CIVIL DRAWINGS.		ВY	Ŋ	2	Wap		
10 BUS PARKING & STRIPING			,				
(1) CONCRETE RETAINING WALL, SEE STRUCTURAL DRAWINGS.							
(12) EXISTING BRIDGE SUPPORT CONCRETE COLUMNS.							
13 NOT USED	SN	NOI					
(14) LANDSCAPE AREA, SEE CIVIL AND LANDSCAPE DRAWINGS.	REVISIONS	ESCRIPTION		ИTS			
(15) STACKED BLOCK RETAINING WALL. SEE STRUCTURAL DRAWINGS.				A COMMENTS			
$(16) \begin{array}{c} \text{DECORATIVE METAL FENCE, SEE} \\ \text{A-8004.} \end{array}$			FOR BID	d per dsa			
17 INTEGRAL COLORED CONCRETE SIDEWALK. REFER TO SPECIFICATIONS FOR COLOR.			-16 ISSUED	-17 REVISED			
18) TREE WELL GRATE. REFER TO LANDSCAPE DRAWINGS.). DATE	∑ 10-31-16	02-07			
(19) OUTDOOR STORAGE AREA WITH CHAIN LINK FENCE.		NO.	\triangleleft				
20 ACCESSIBLE VAN PARKING STALL, SEE CIVIL DRAWINGS & 6/A-1033.			2				
(21) CONCRETE SIDEWALK, SEE CIVIL DRAWINGS. AND SHEET A-1033 & A-6001 FOR DETAILS.			PROGRAN	≻		EAST	
22) BOLLARD, SEE B/A-8005.					5	Ι	
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(26) POST MOUNTED ADA SIGNAGE. POST SHALL BE SET IN A SLEEVE PLACED ON TOP OF THE CONCRETE RETAINING	CONTRACT NO.				SHEET TITLE		
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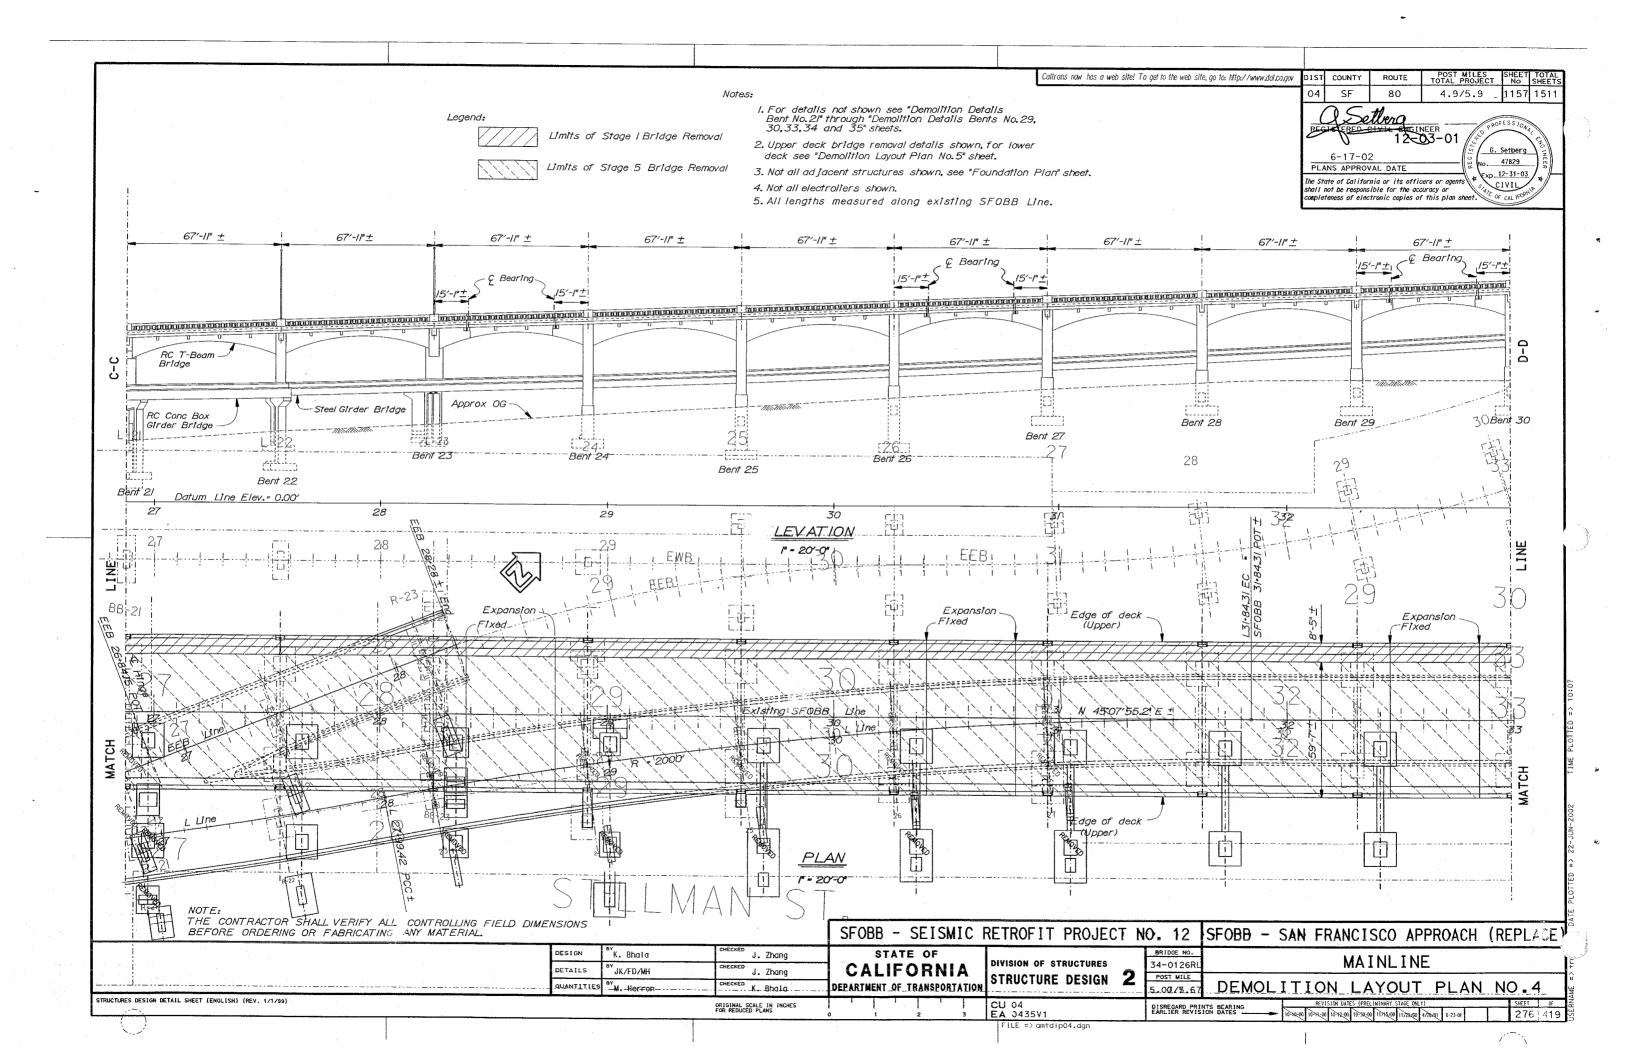



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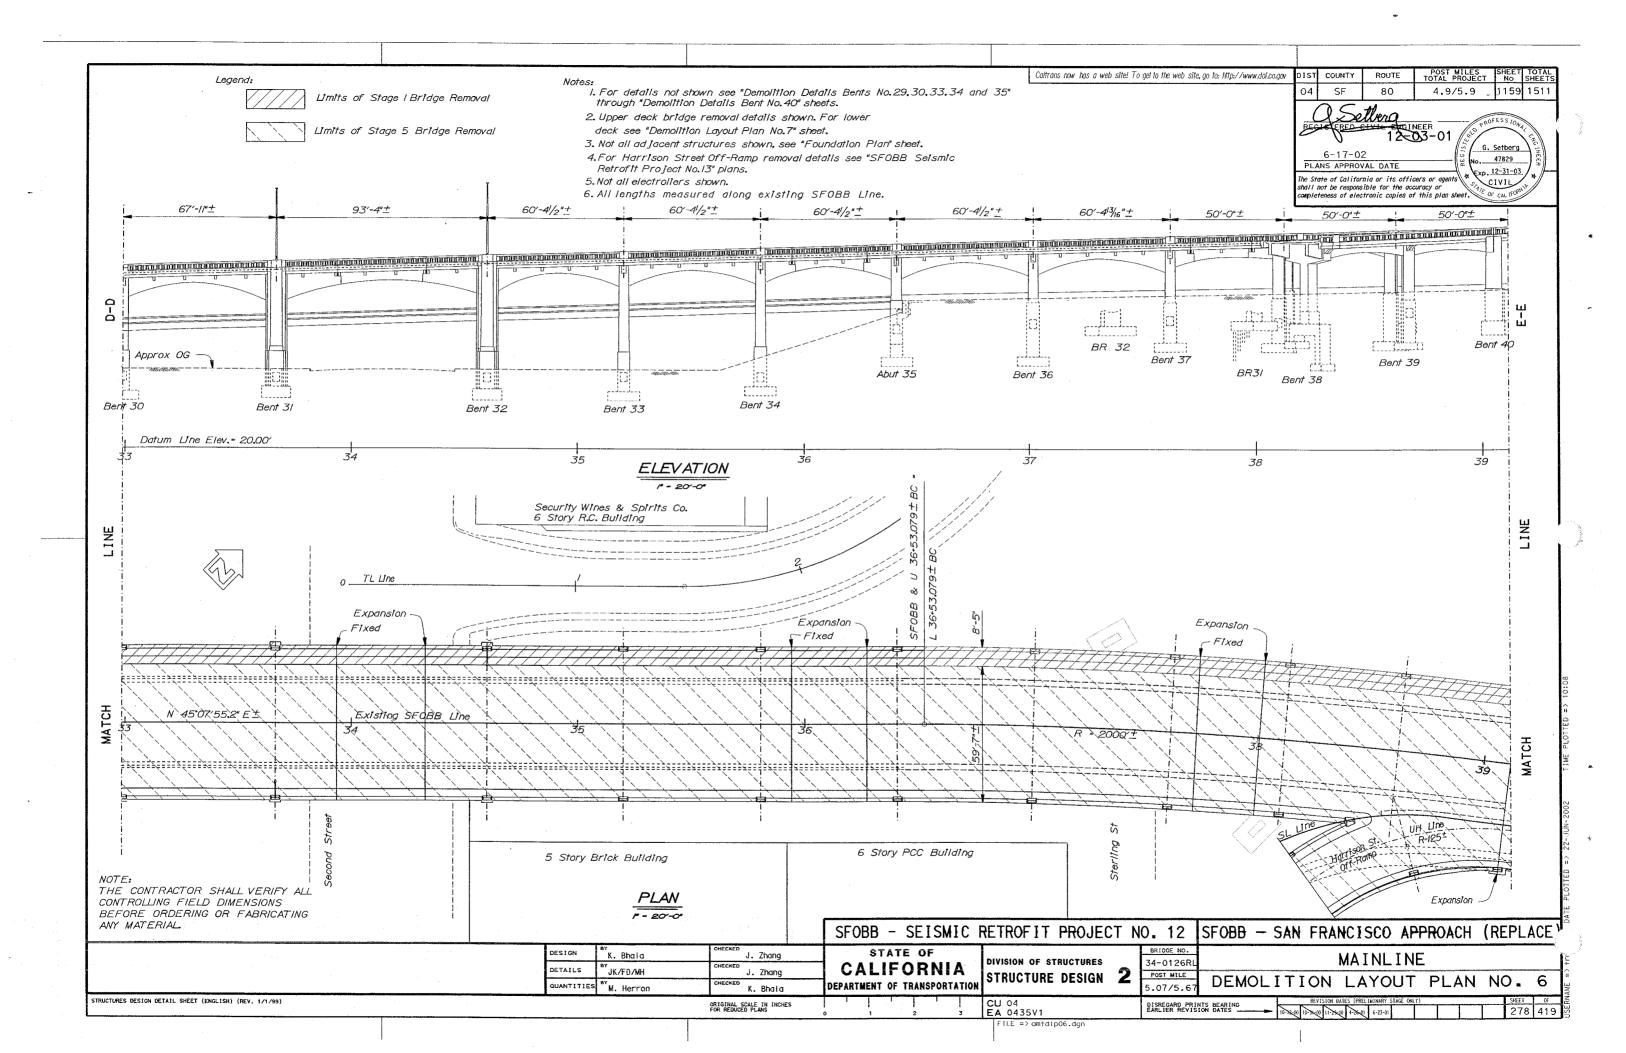


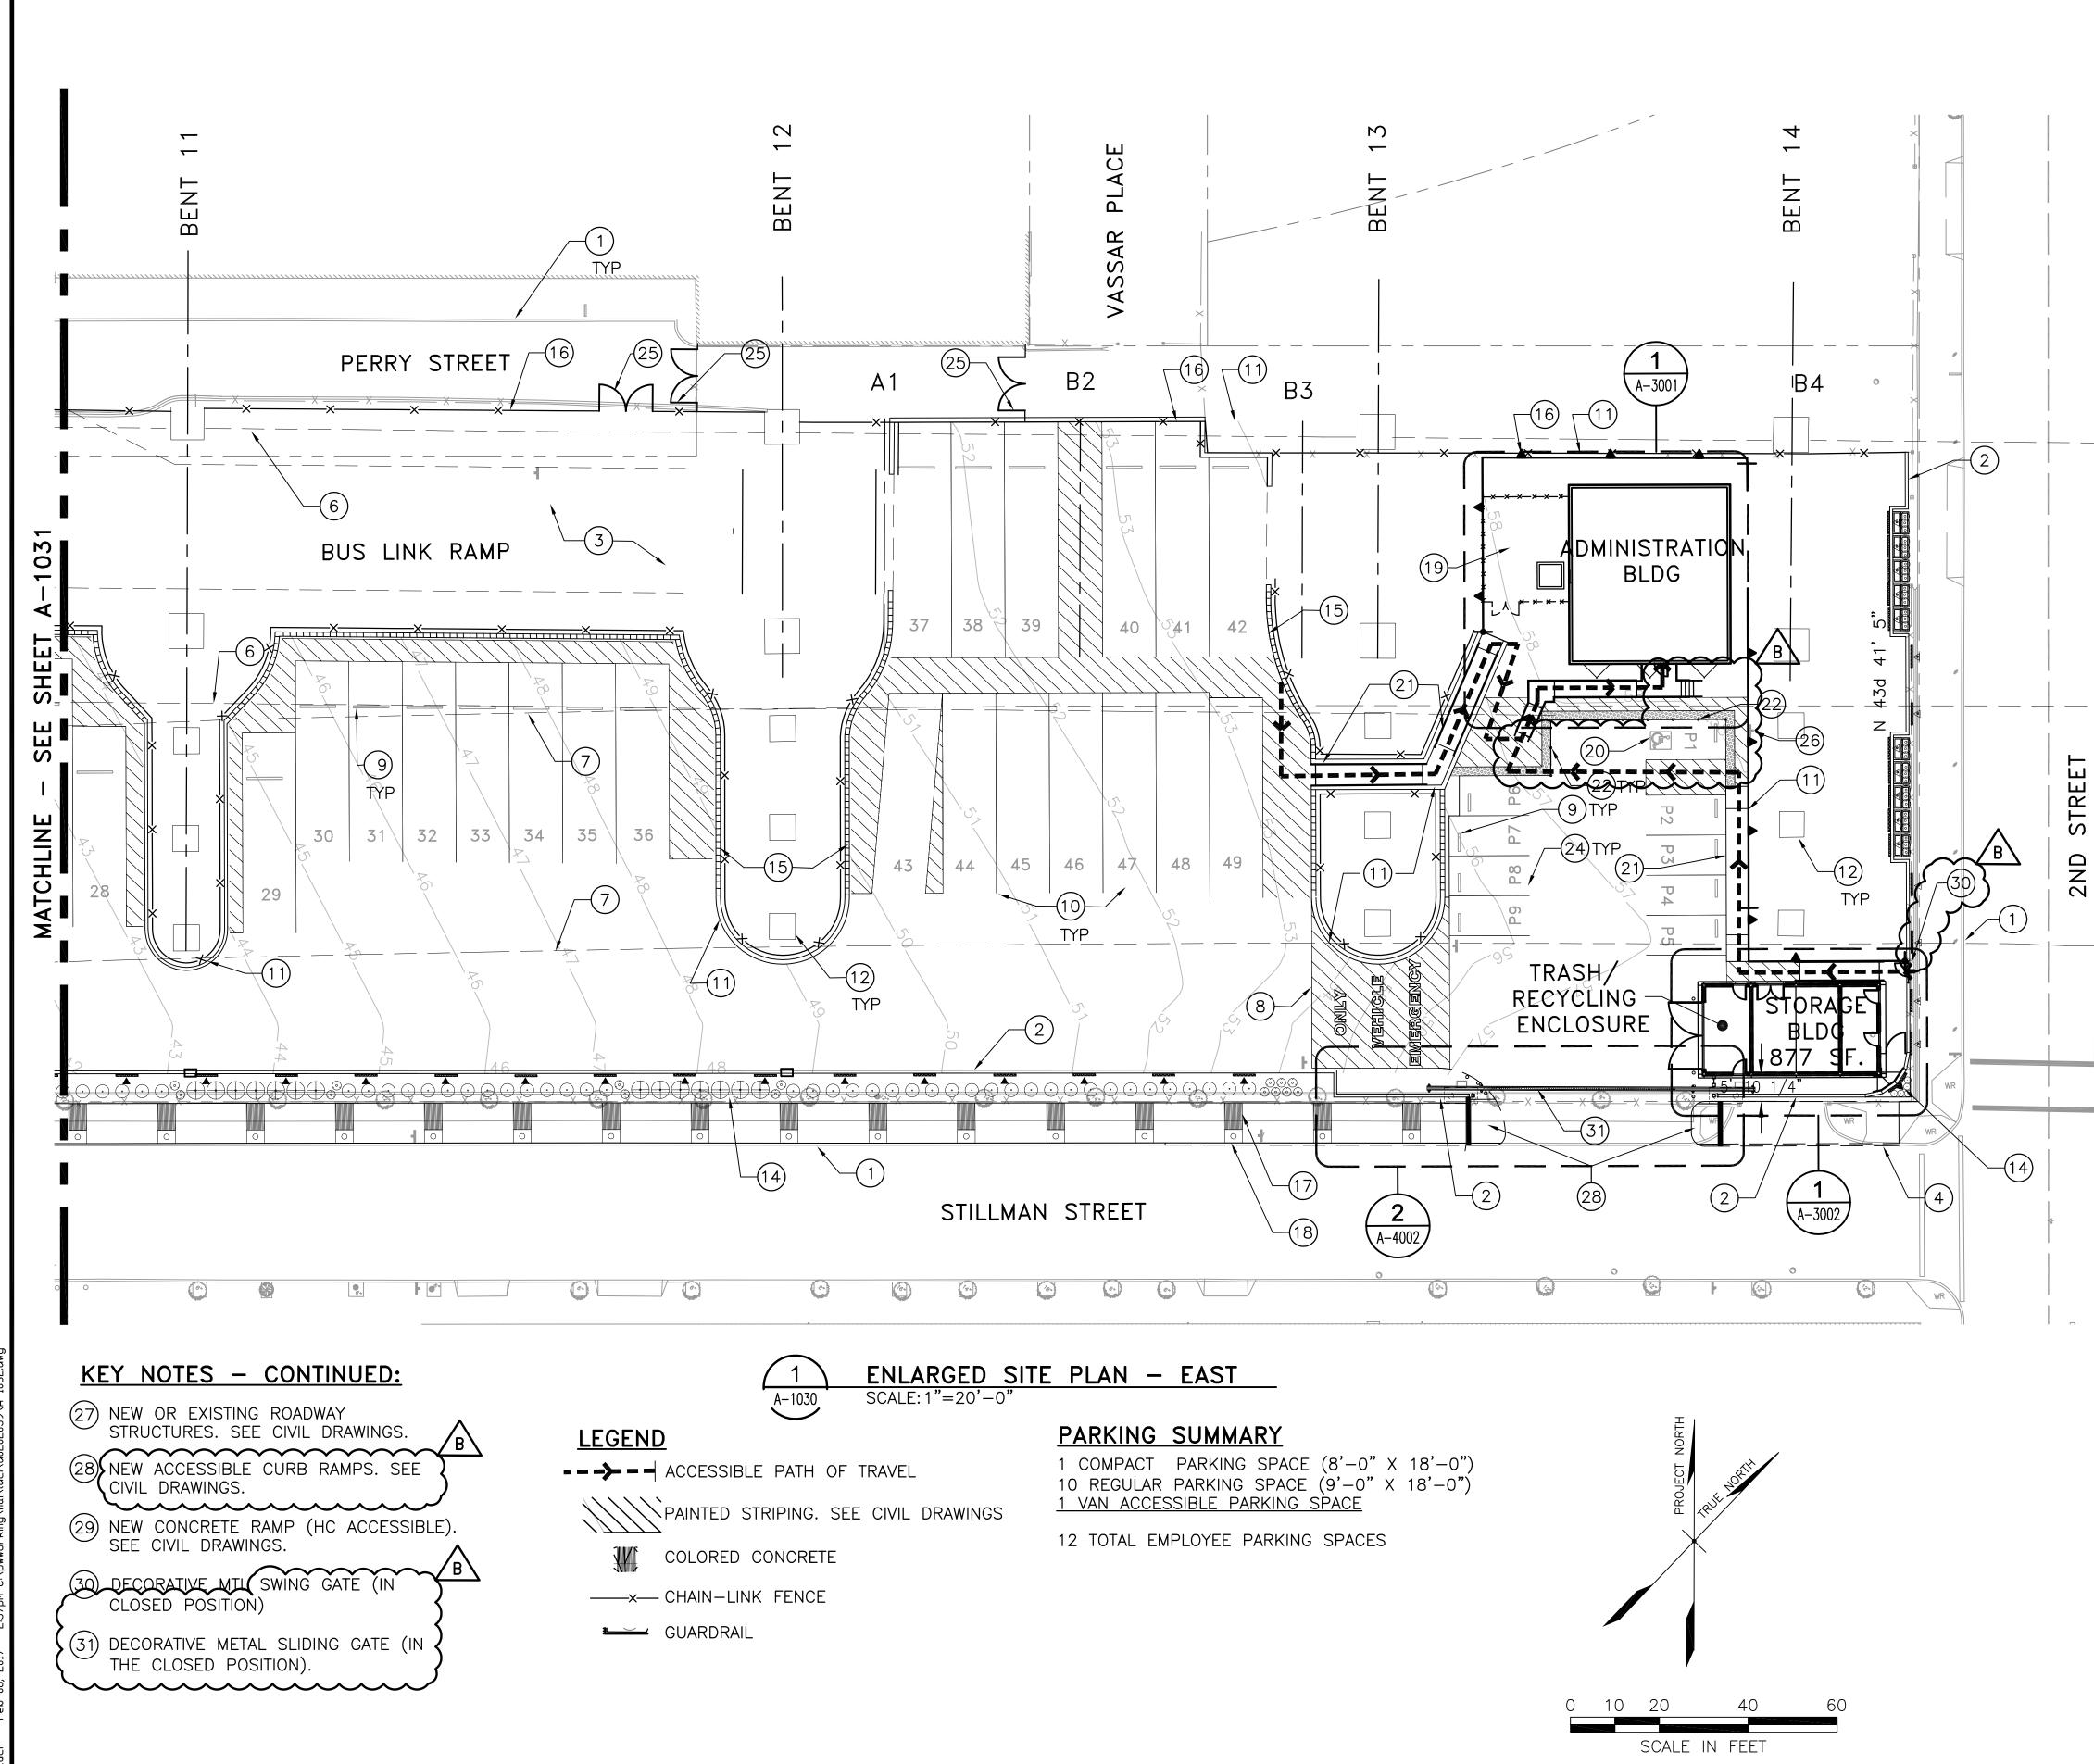


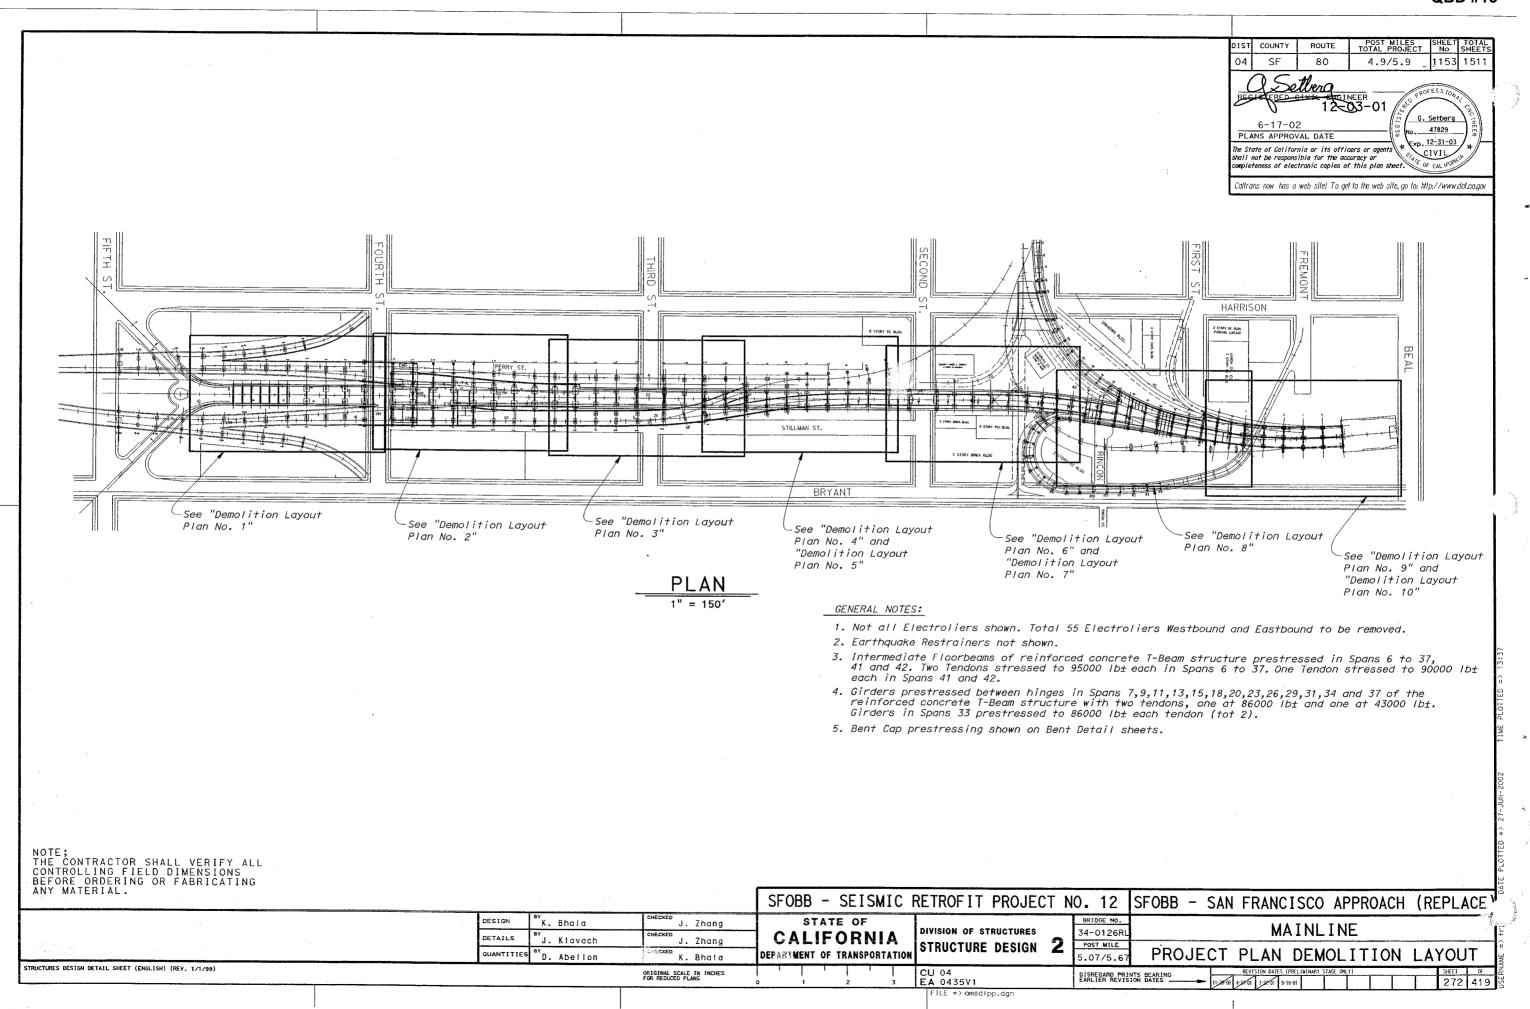





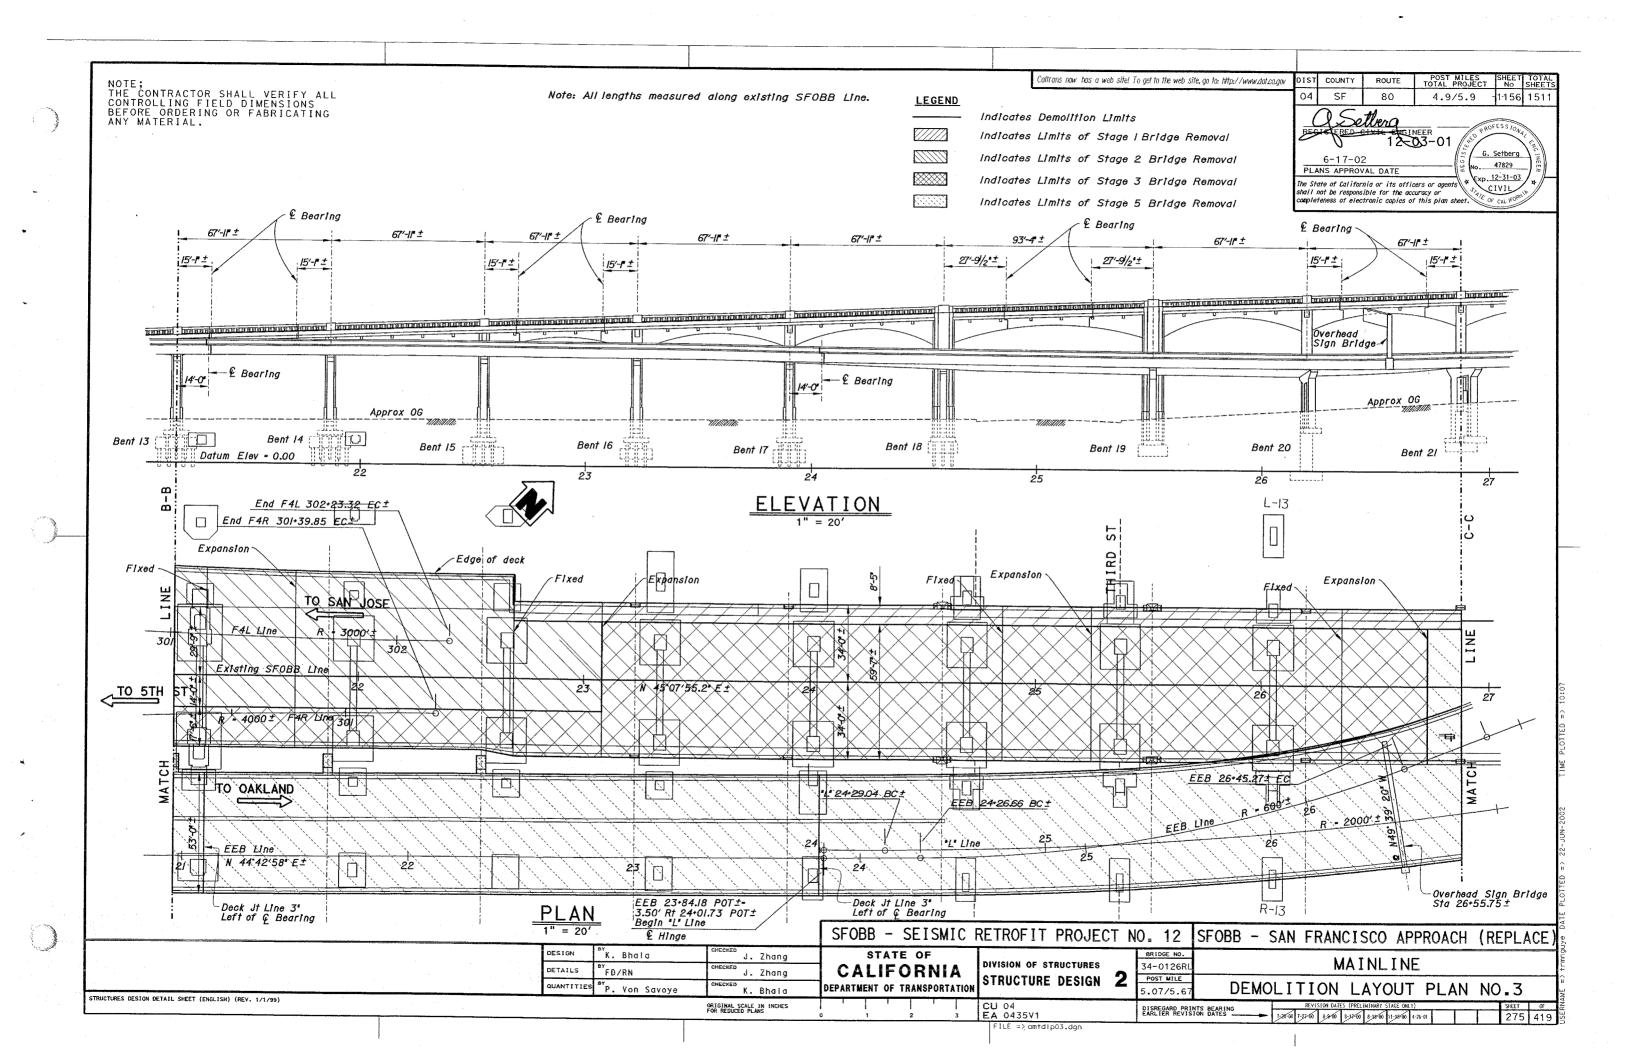


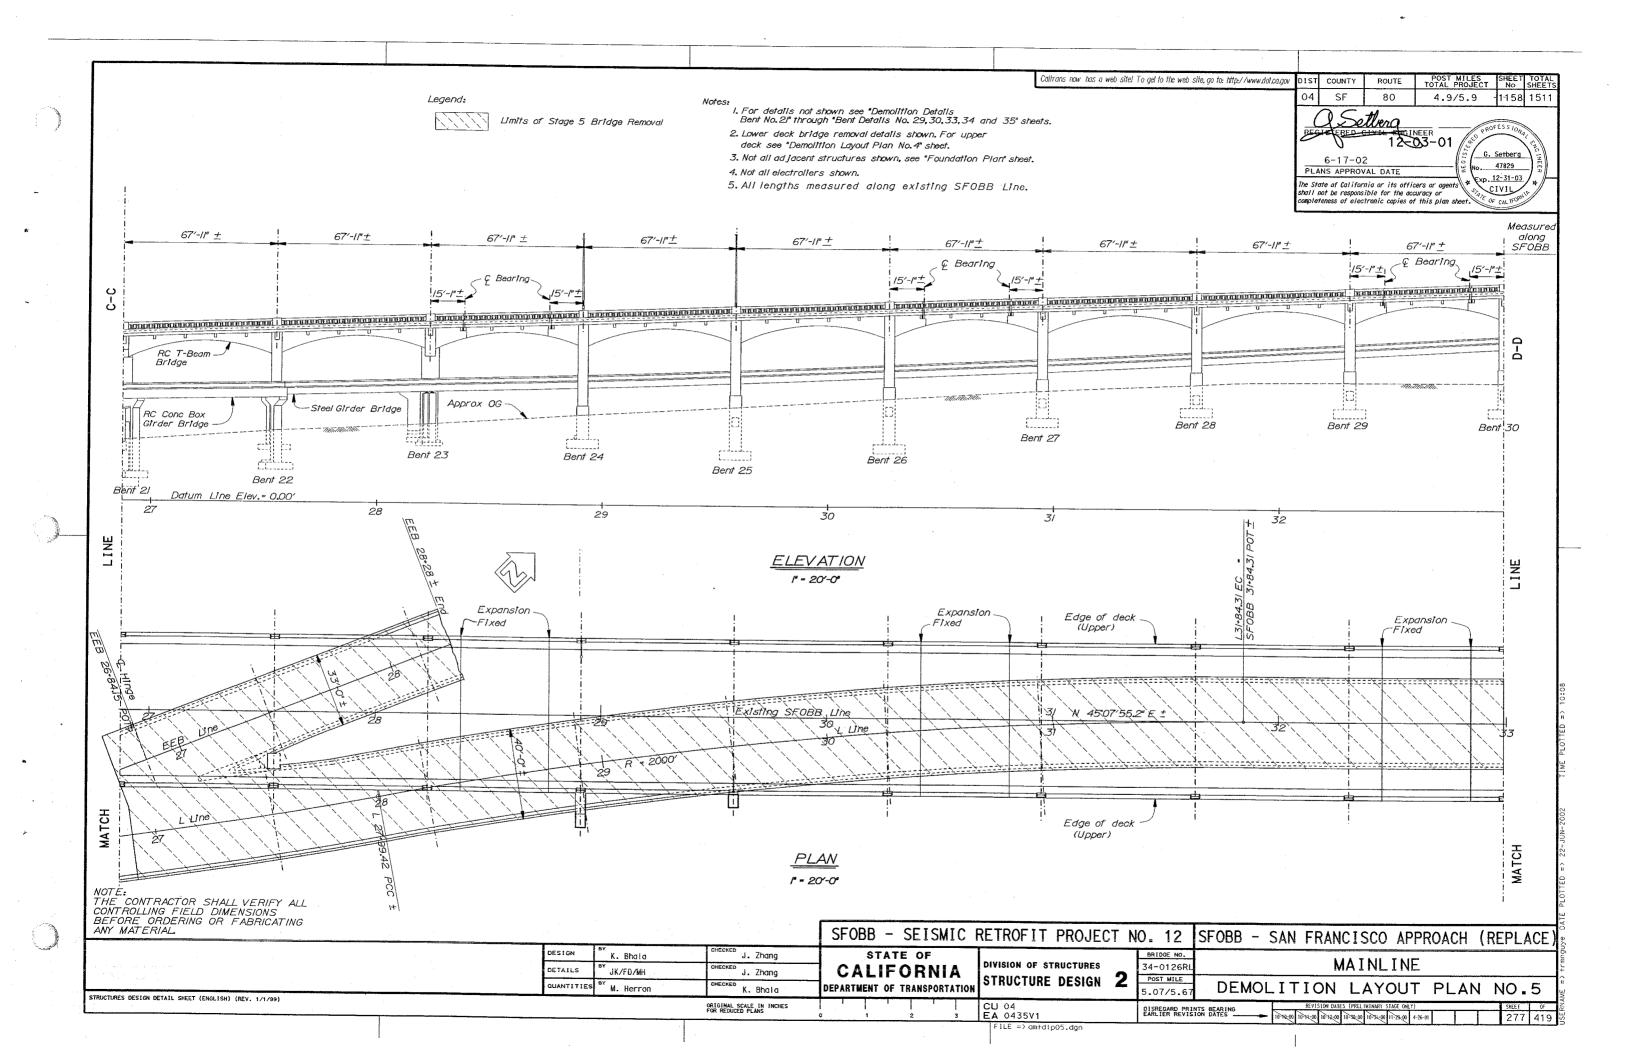


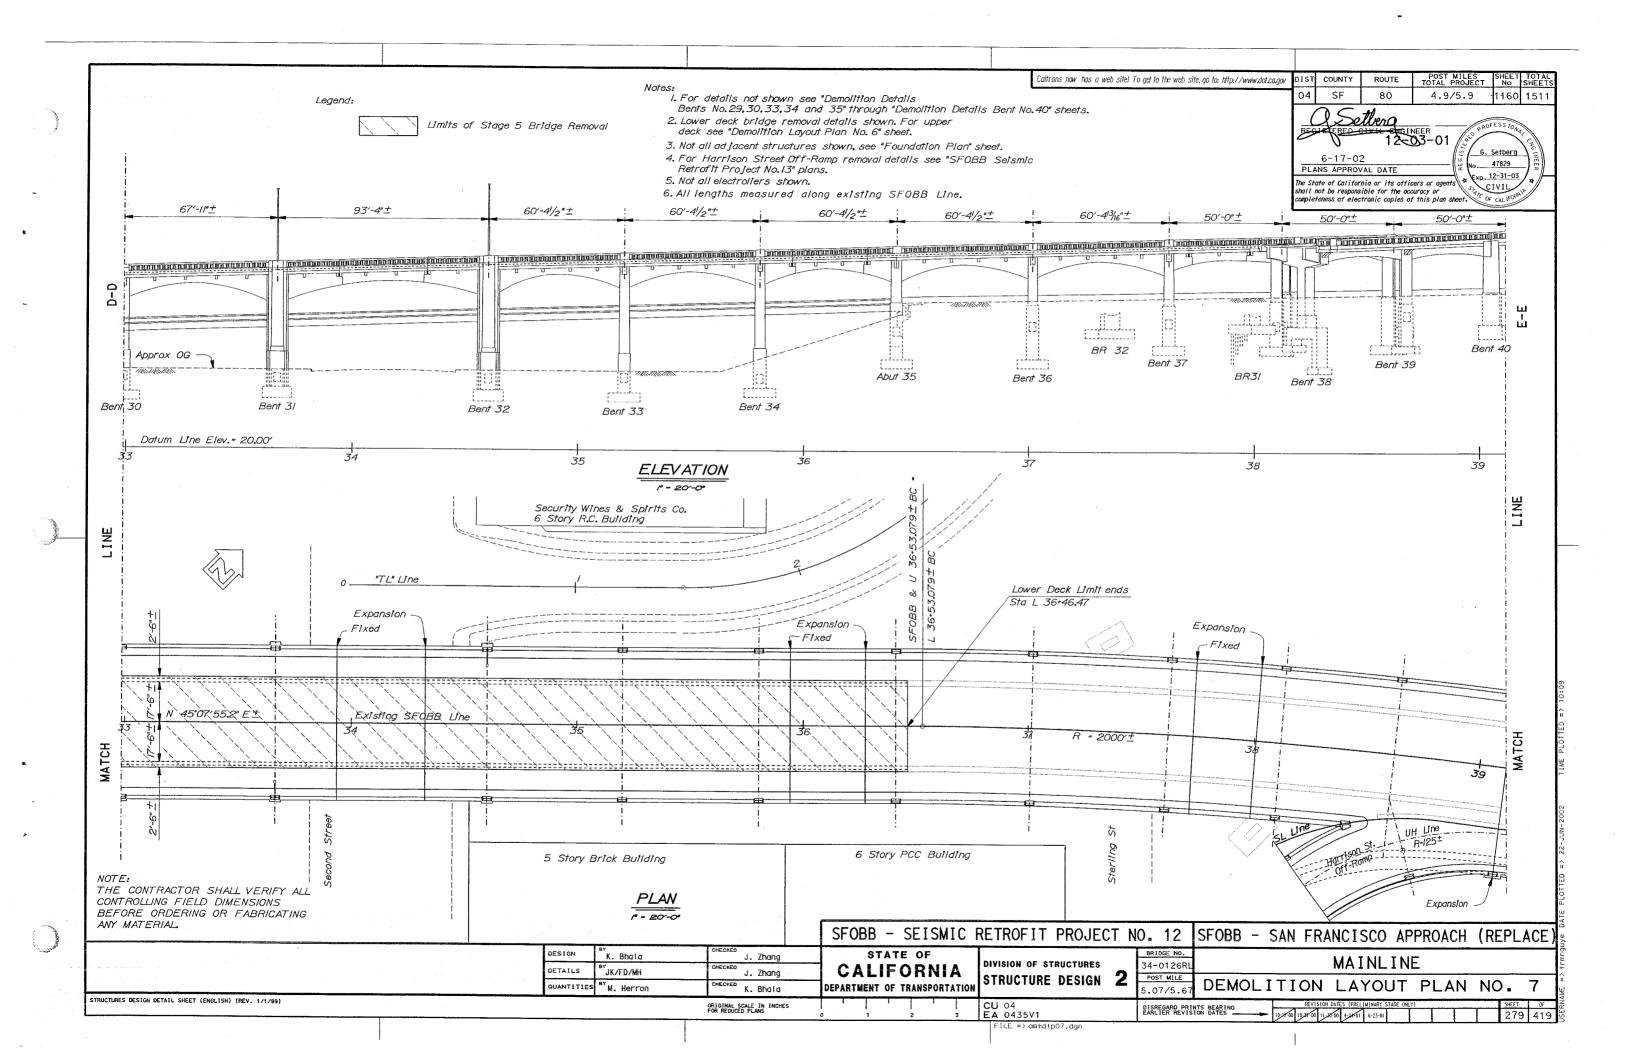

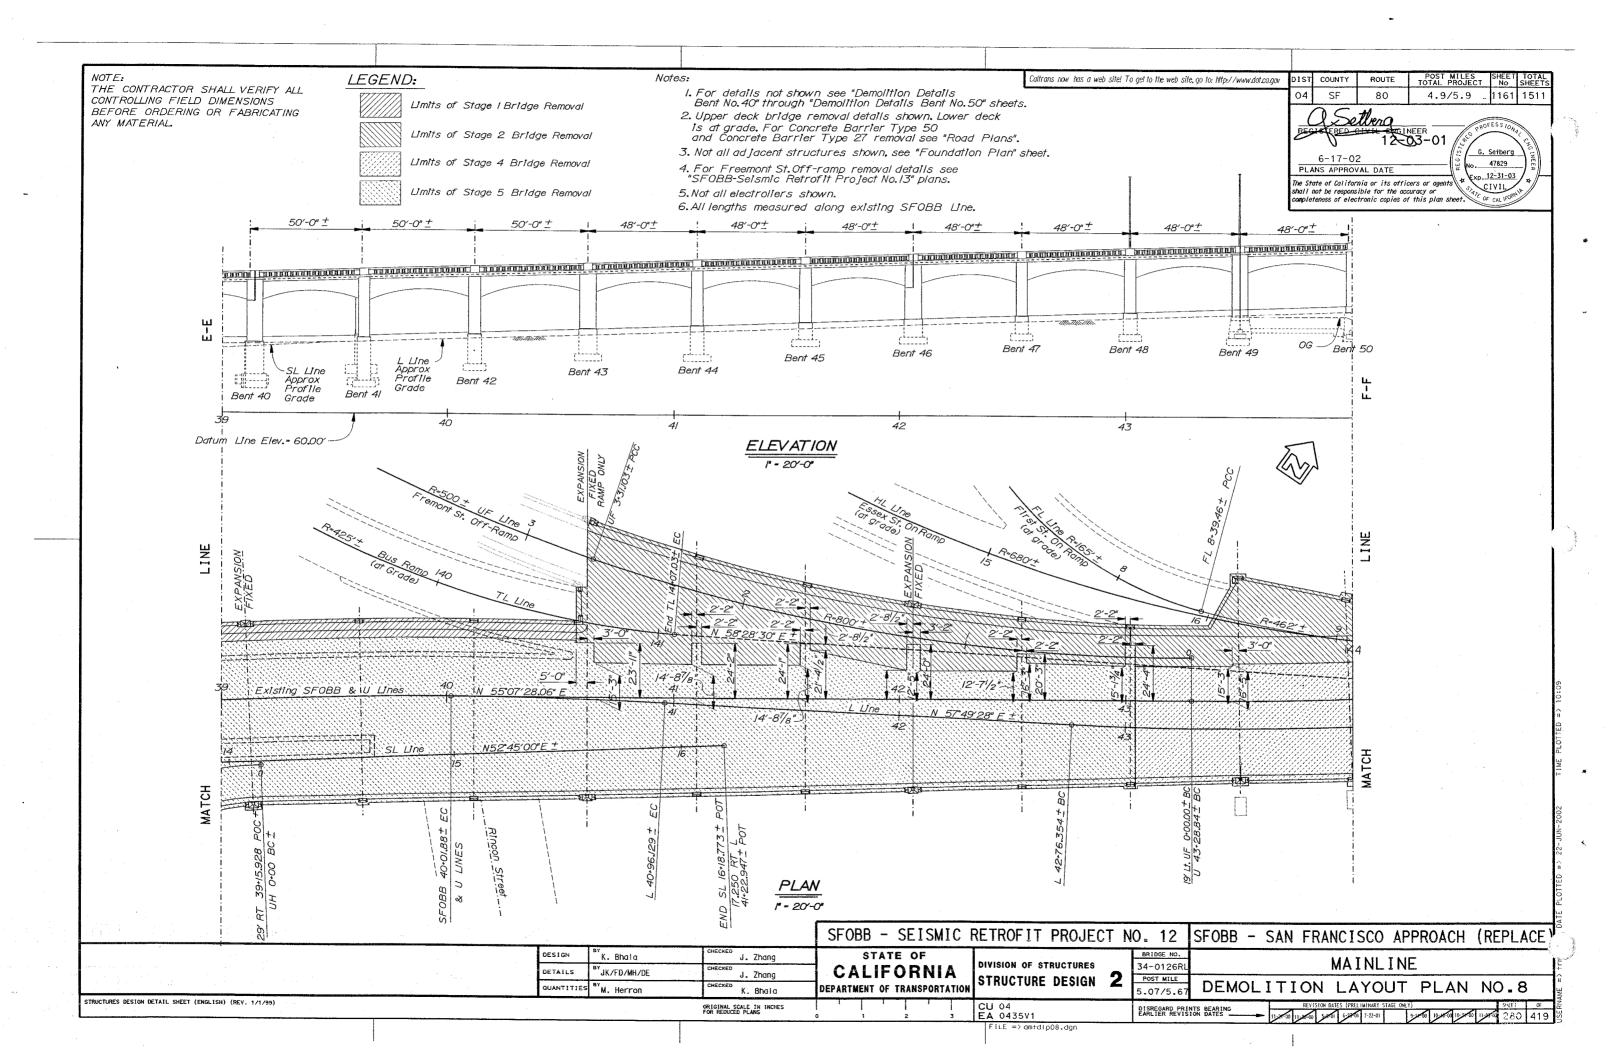

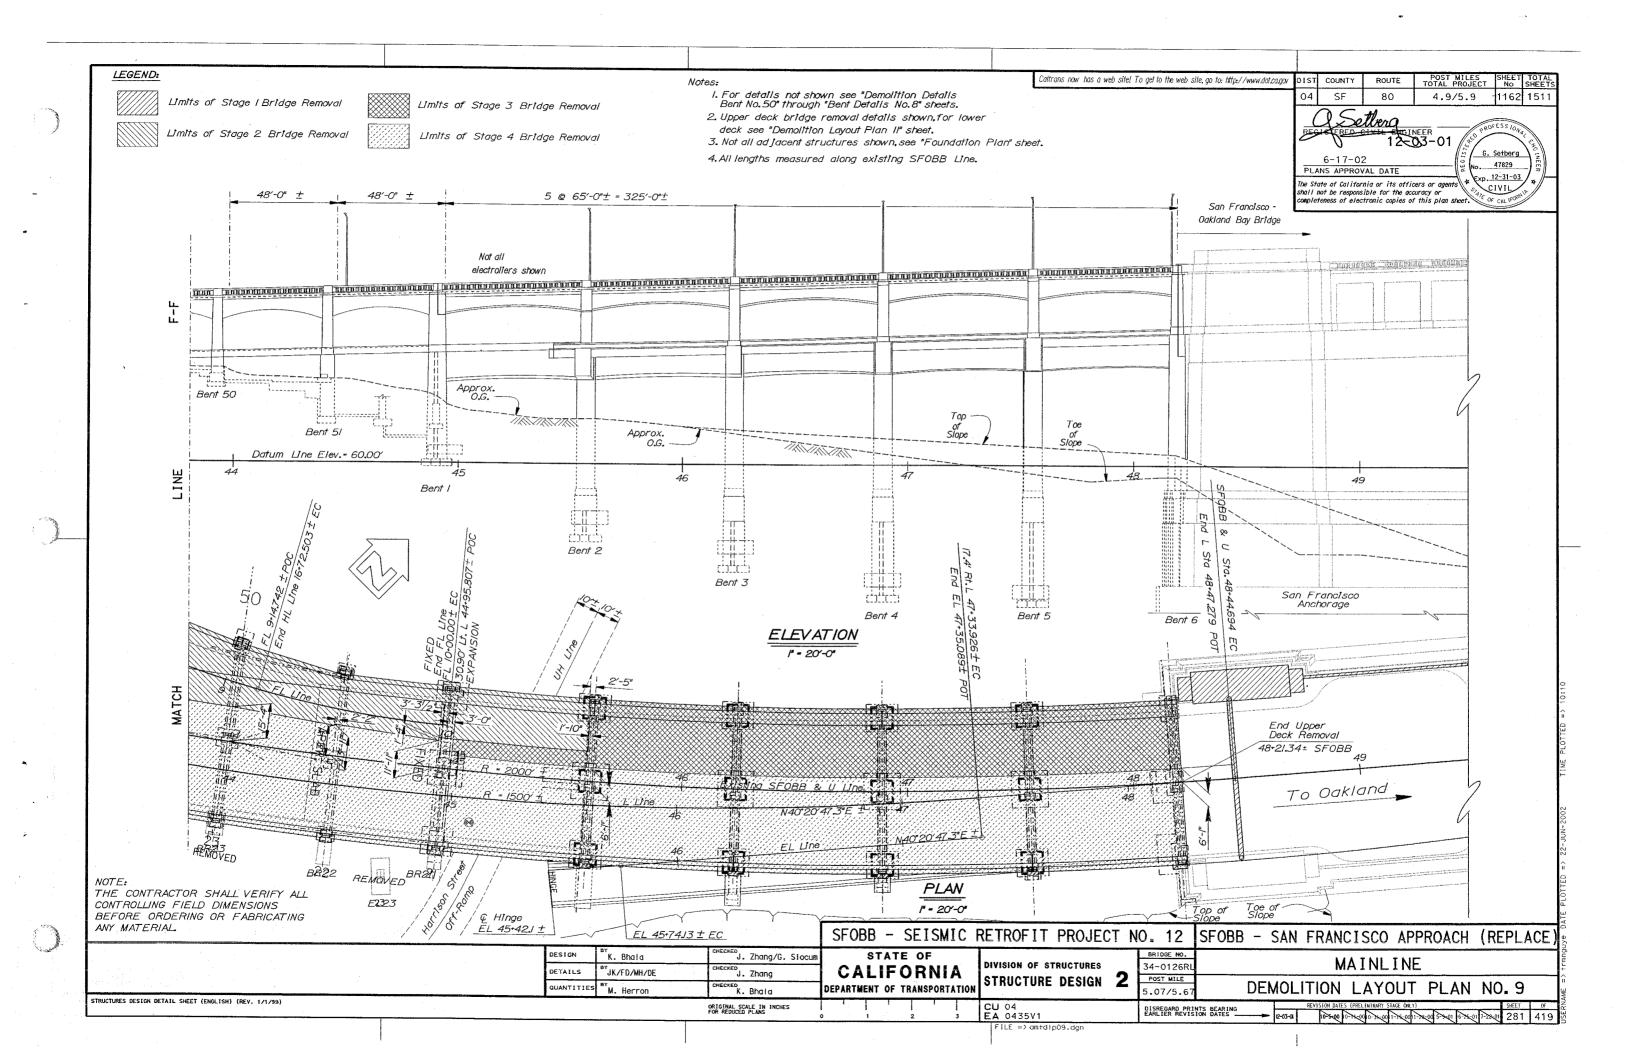


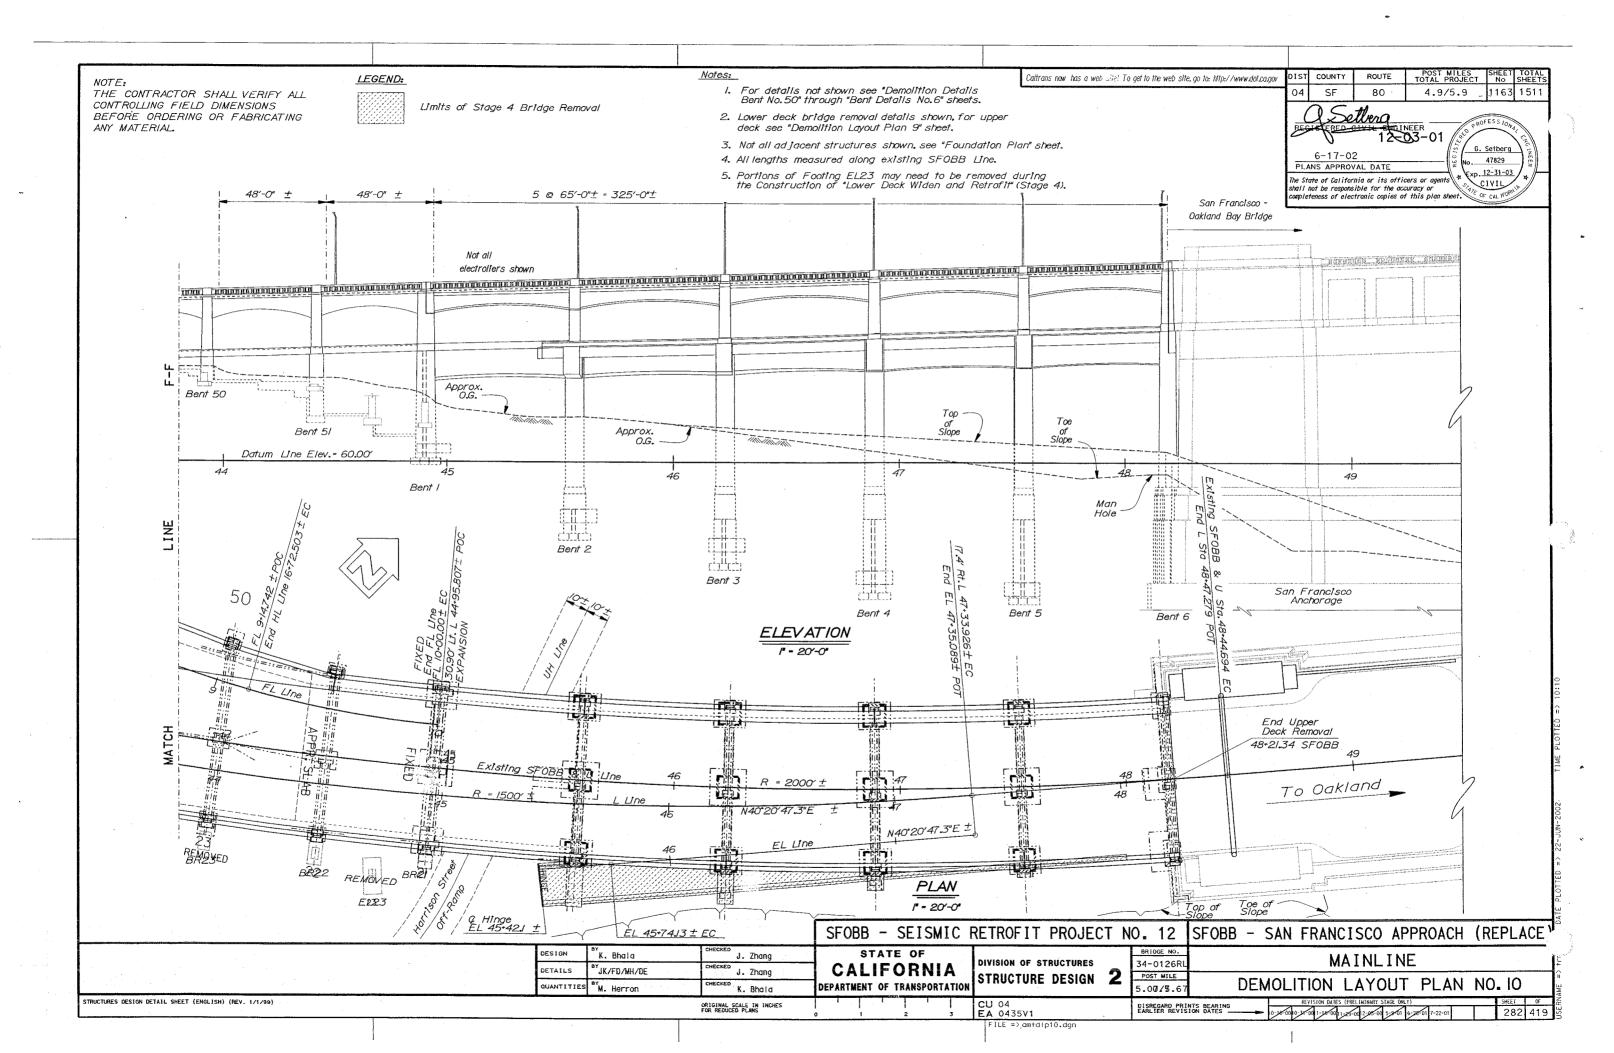


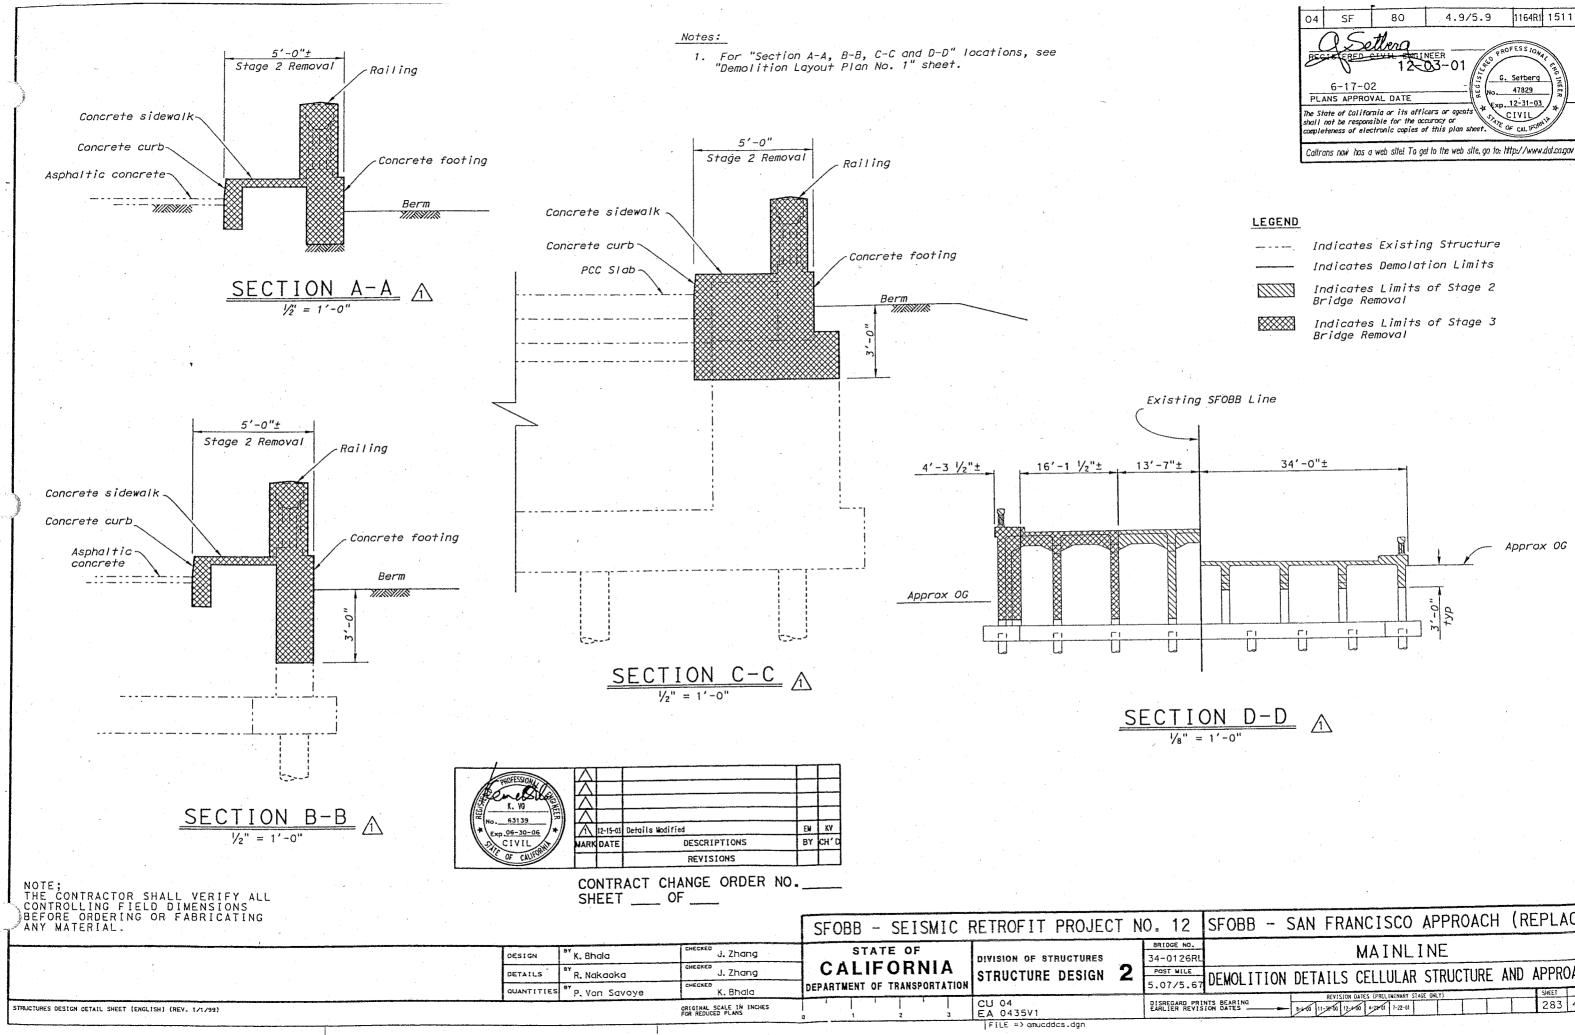


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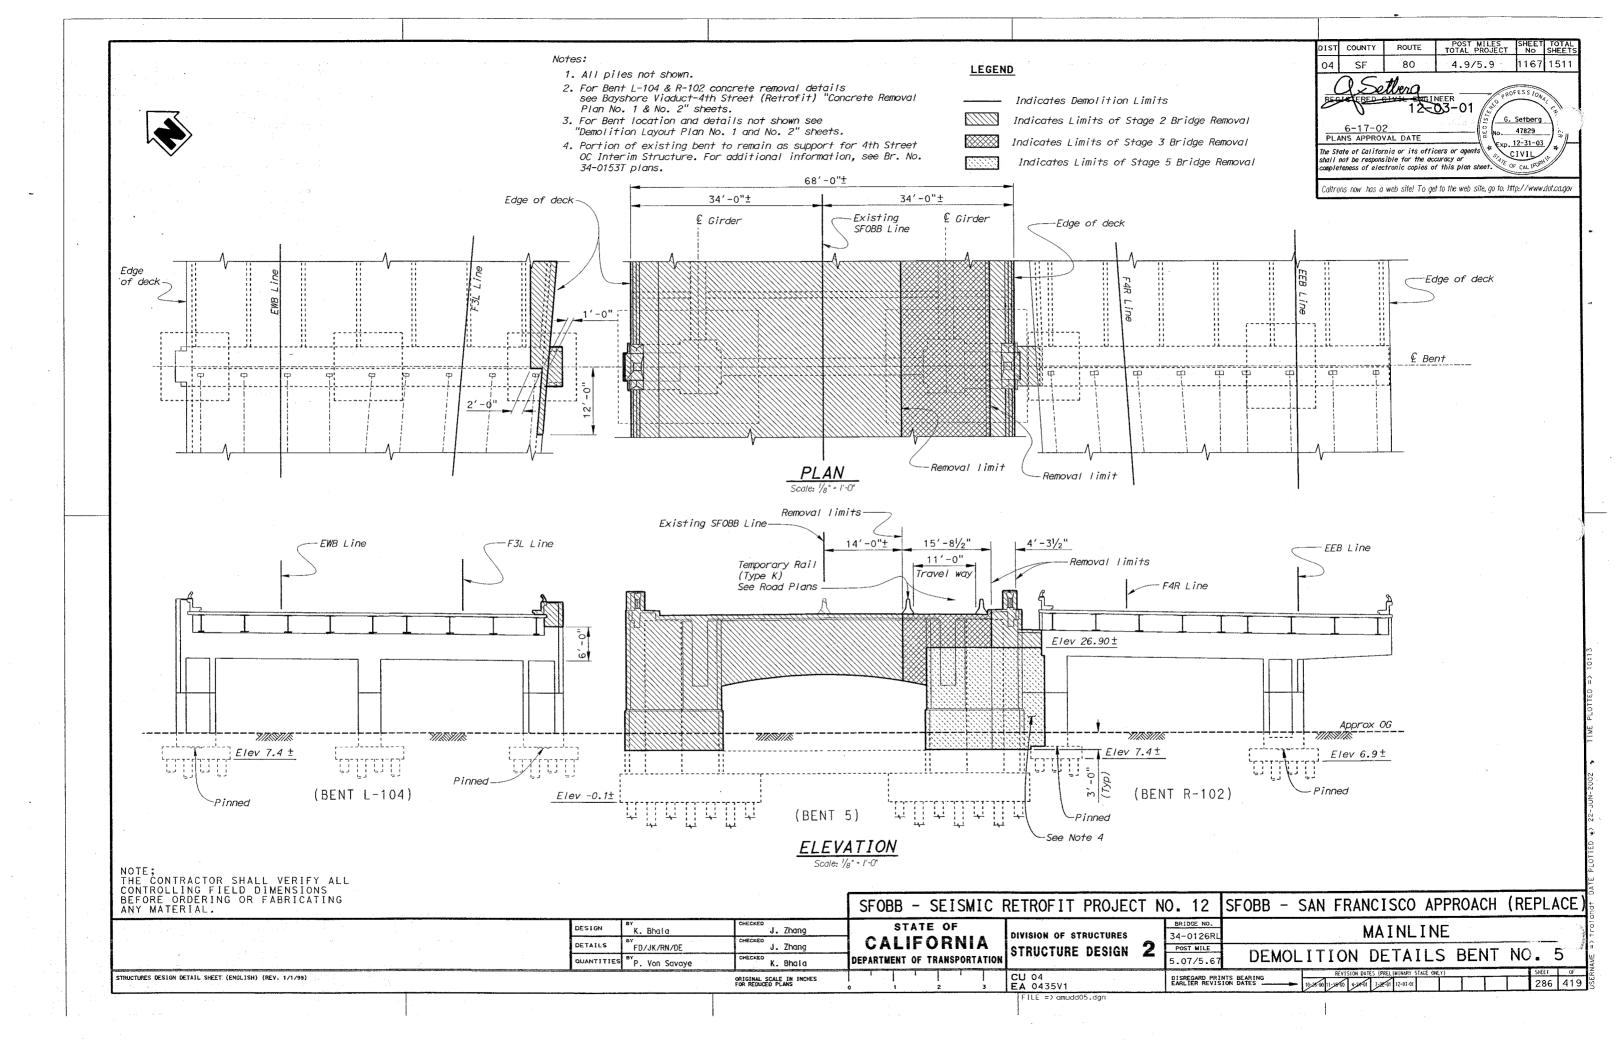
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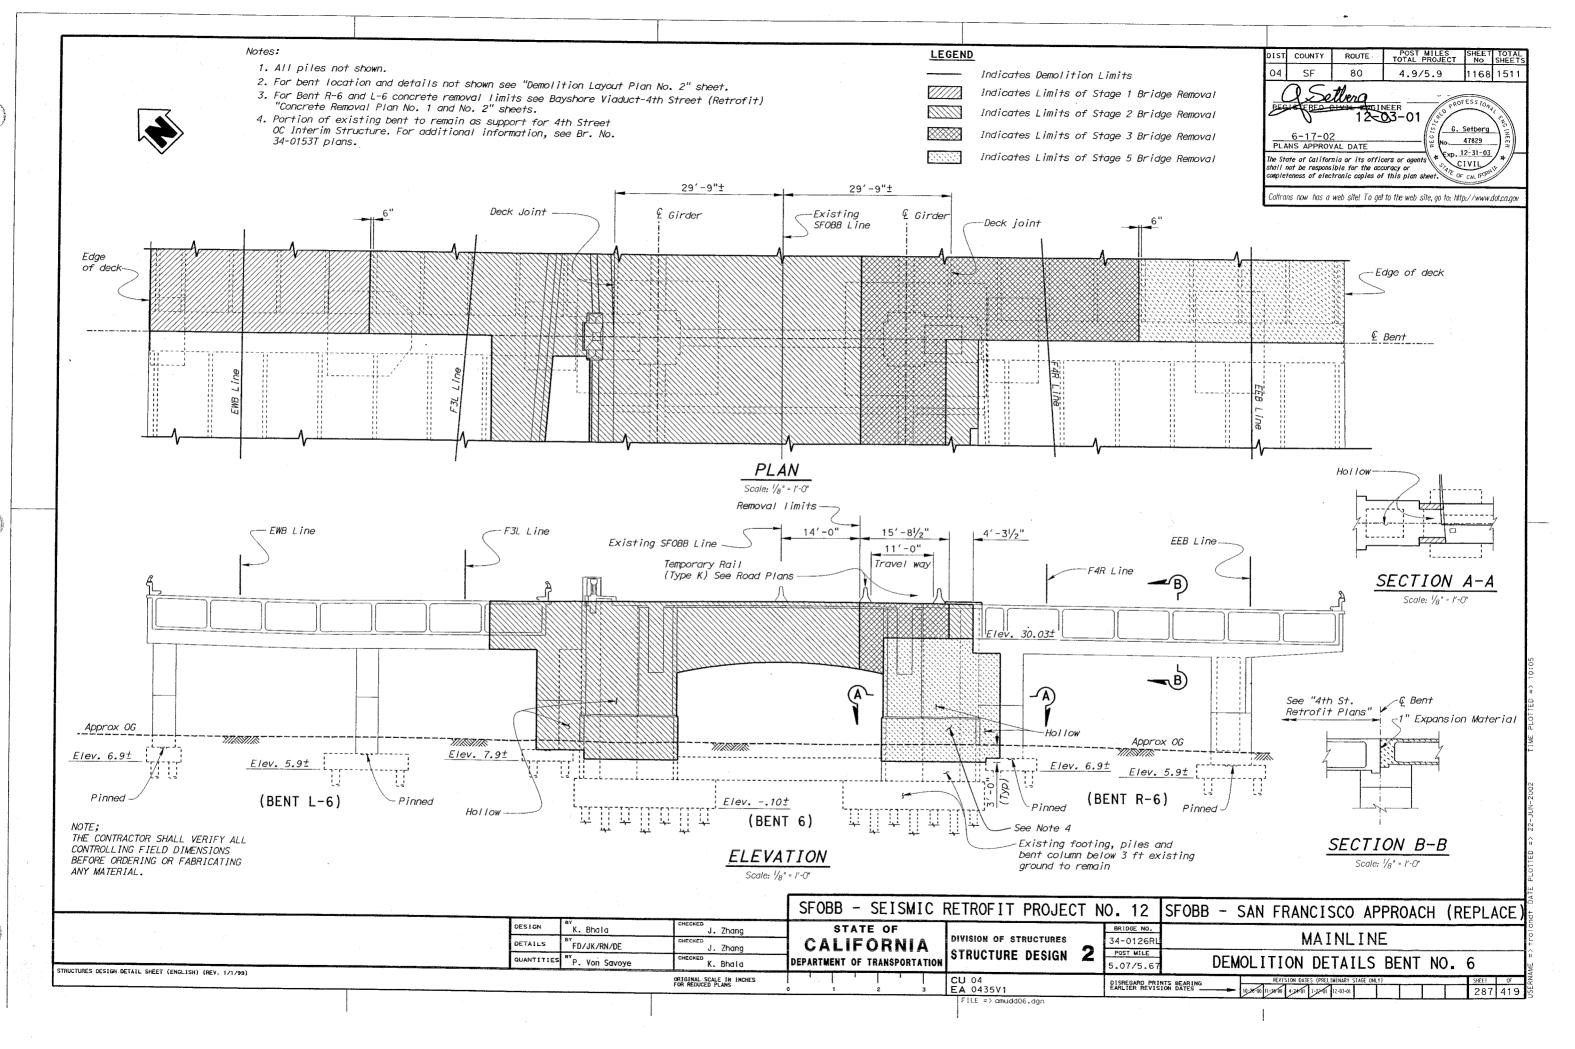
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Notes:


- 1. All piles not shown.
- 2. Bent 4 shown, Bents 2 & 3 similar.
- 3. For Bent locations and details not shown see "Demolition Layout Plan No. 1" sheet.

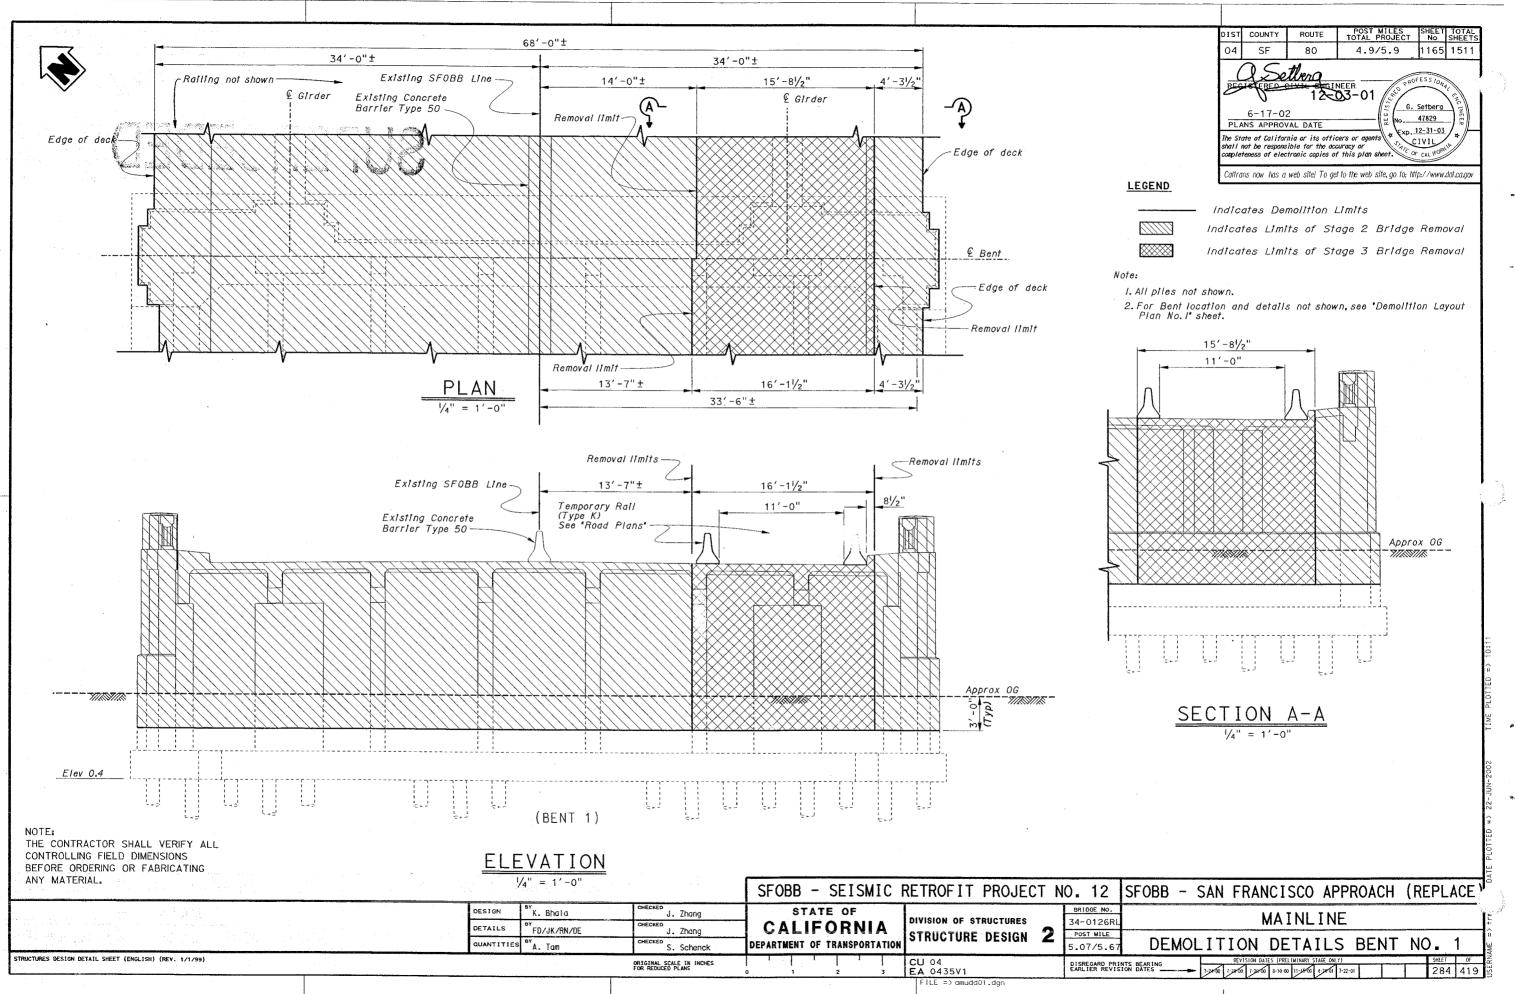
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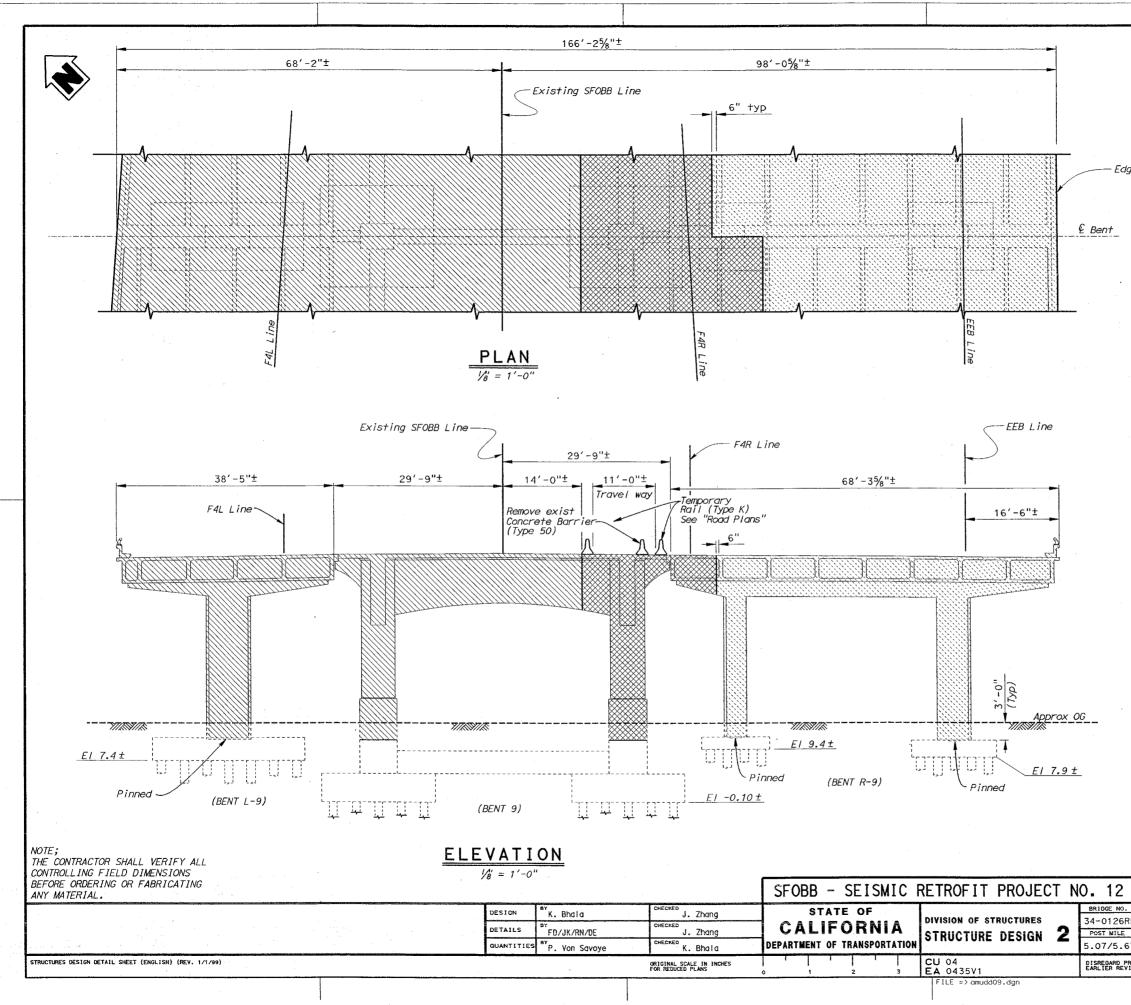

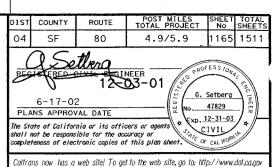
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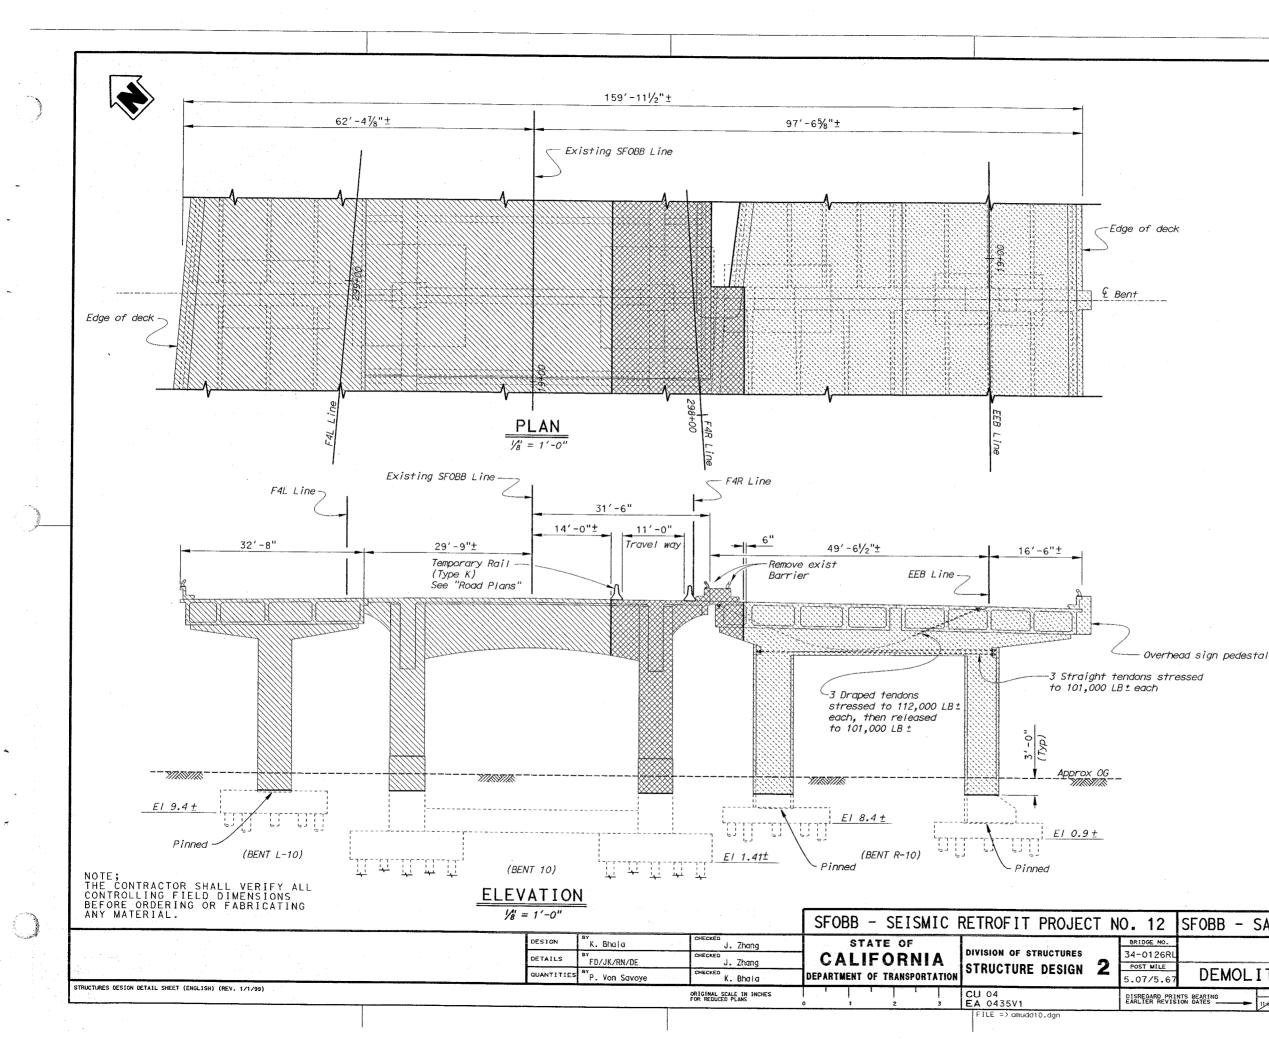


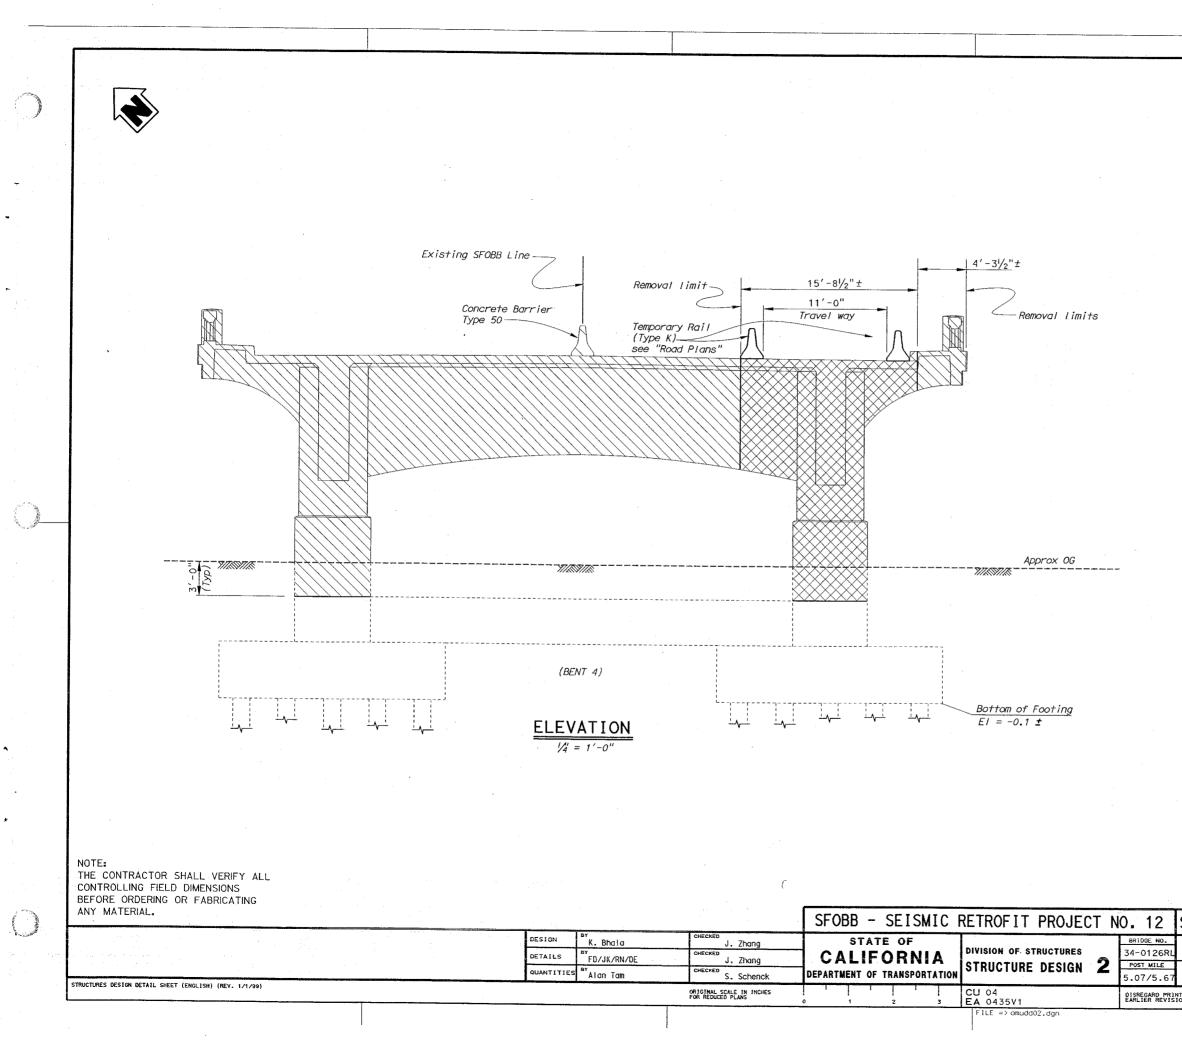



COUNTY ROUTE POST MILES TOTAL PROJEC NO SHEET 04 SF 4.9/5.9 1170 151 80 a Settera OFESS 12-03-01 G. Setberg 6-17-02 47829 PLANS APPROVAL DATE Exp. 12-31-03 The State of California or its officers or agents CIVIL hall not be responsible for the accuracy or completeness of electronic copies of this plan shee OF CAL I Caltrans now has a web site! To get to the web site, go to: http://www.dot.ca.gov LEGEND ____ Indicates Demolition Limits Indicates Limits of Stage 1 Bridge Removal ----Edge of deck Indicates Limits of Stage 2 Bridge Removal $\langle || \rangle$ € Bent Indicates Limits of Stage 3 Bridge Removal Indicates Limits of Stage 5 Bridge Removal Notes: 1. All piles not shown. For interim support column details, see "Bent L7 Column Support Details", "Bent L8 Column Support Details", "Bent L7 and L8 Column Pile Details", "Bent R7 Column Support Details", and "Bent R8 Column Support Details" sheets. 3. For Bent location and details not shown see "Demolition Layout Plan No. 2" sheet. Approx OG EI 6.9± SFOBB - SAN FRANCISCO APPROACH (REPLACE MAINLINE DEMOLITION DETAILS BENT NO. 8 DISREGARD PRINTS BEARING EARLIER REVISION DATES 11-3-00 11-15-00 4-27-01 289 419

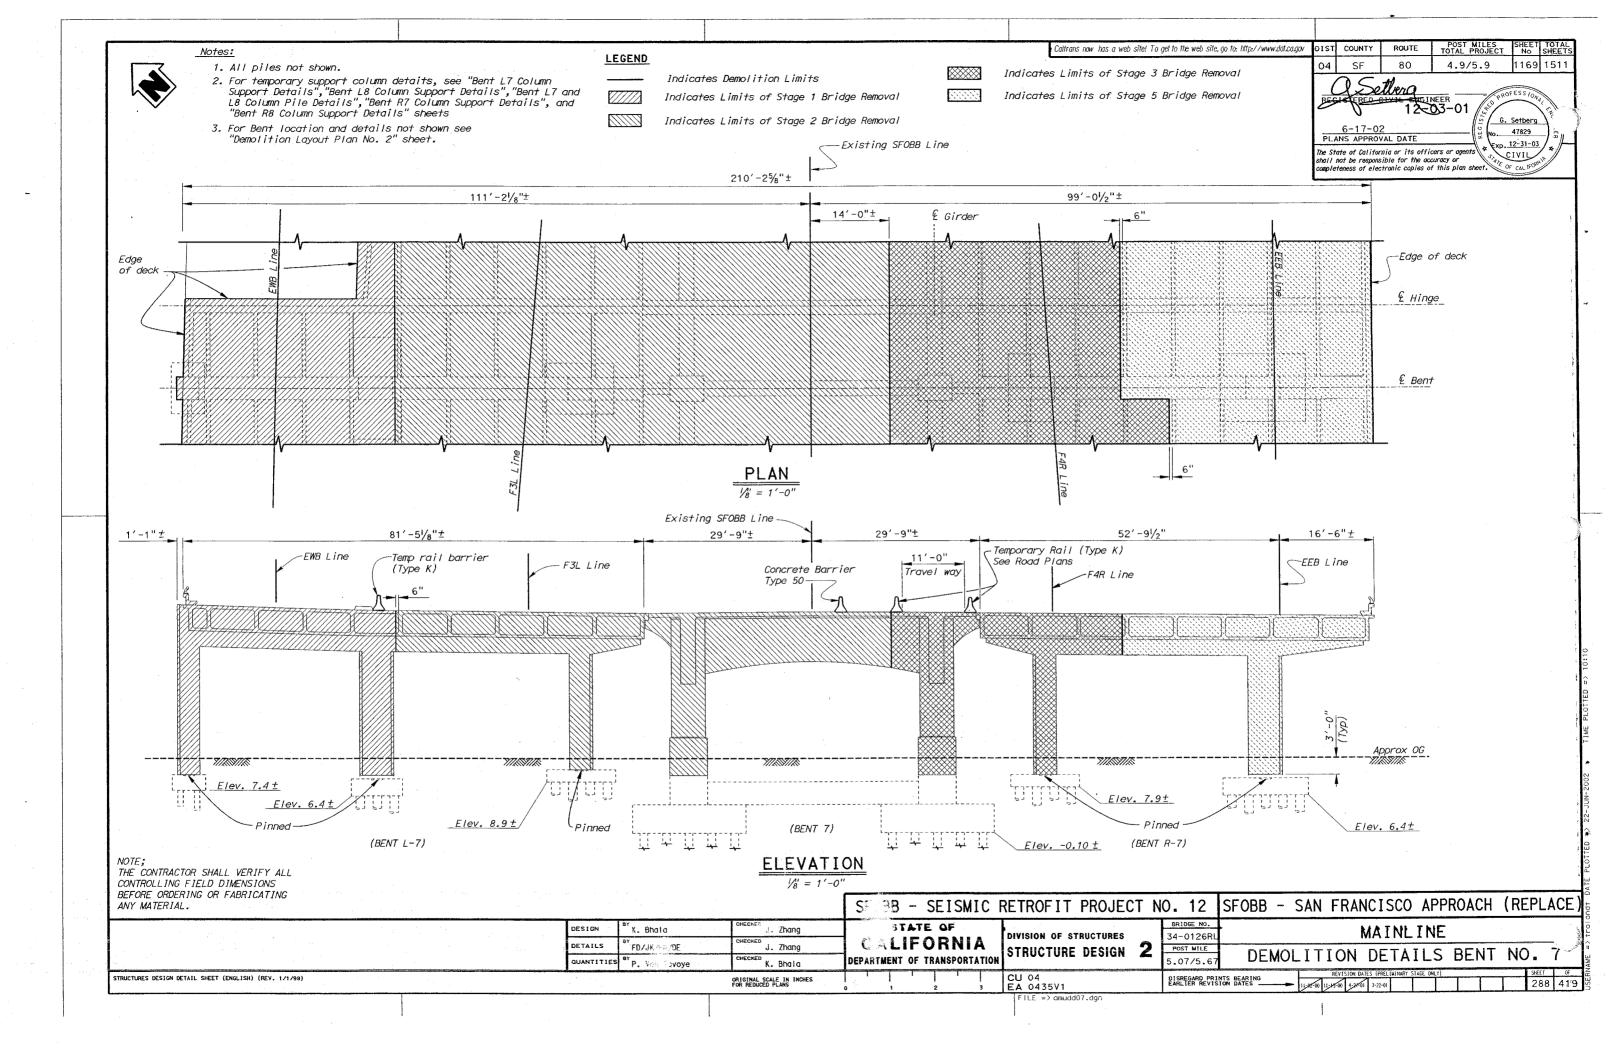

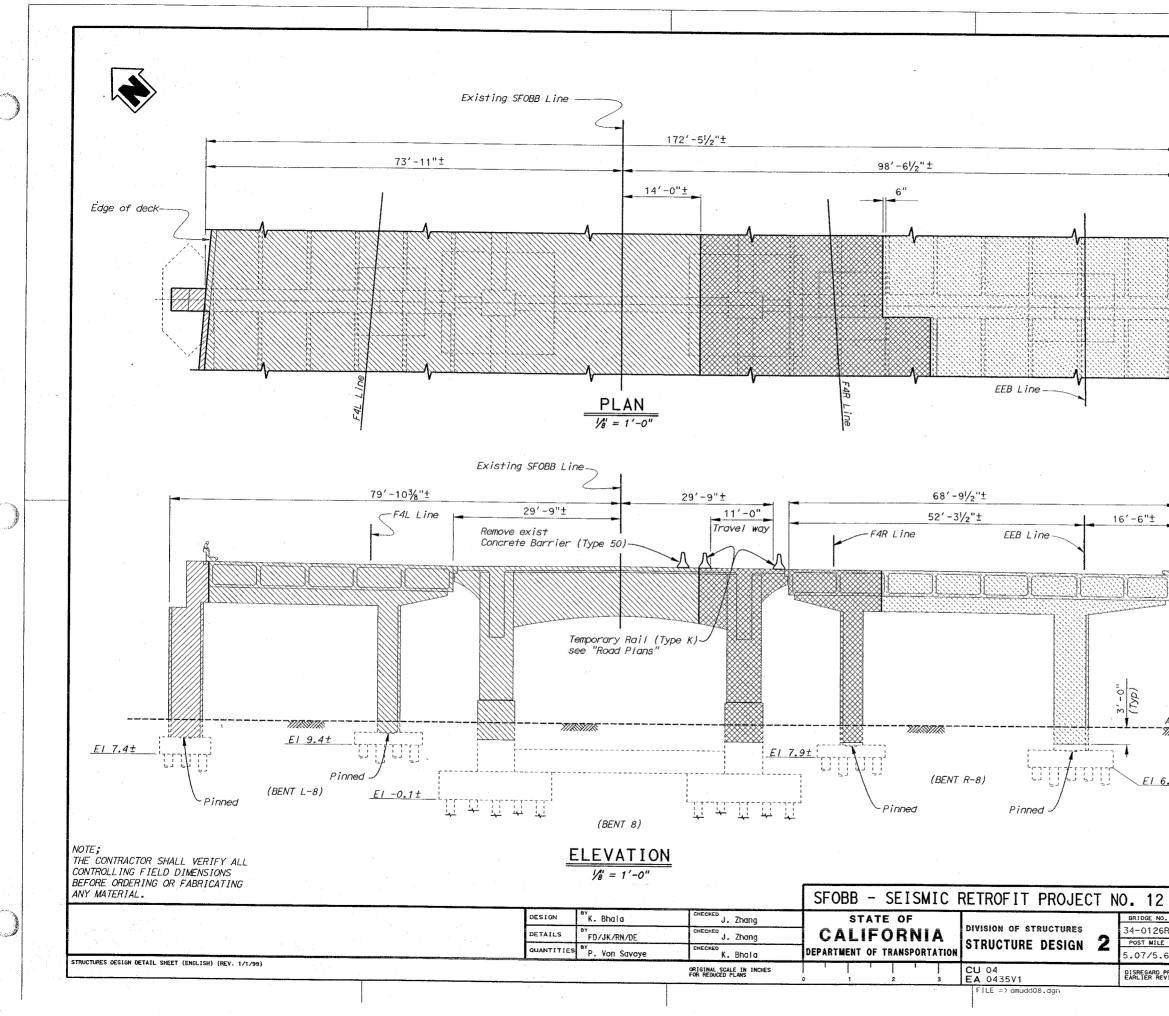
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 $\frac{\text{ELEVATION}}{\frac{1}{8}} = 1' - 0''$

K. Bhala

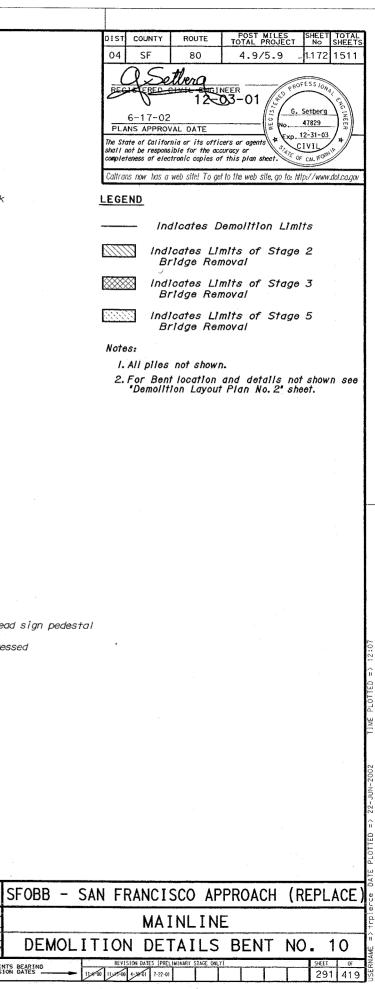FD/JK/RN/DE

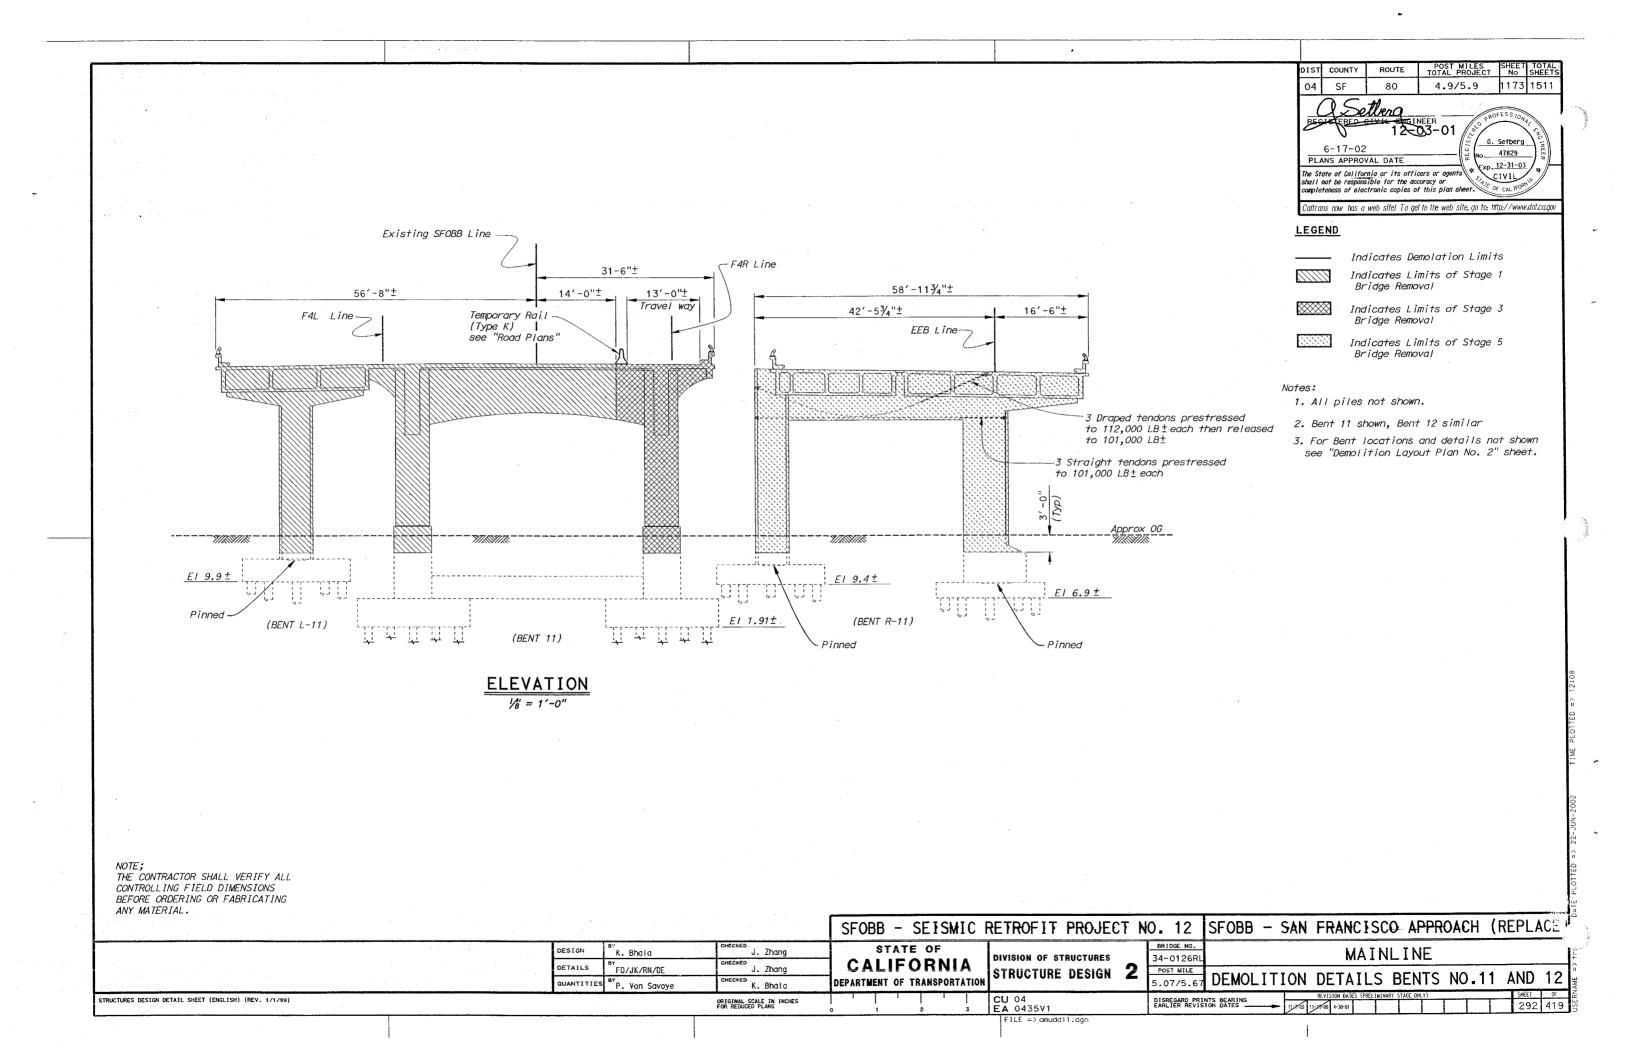D. Abellon

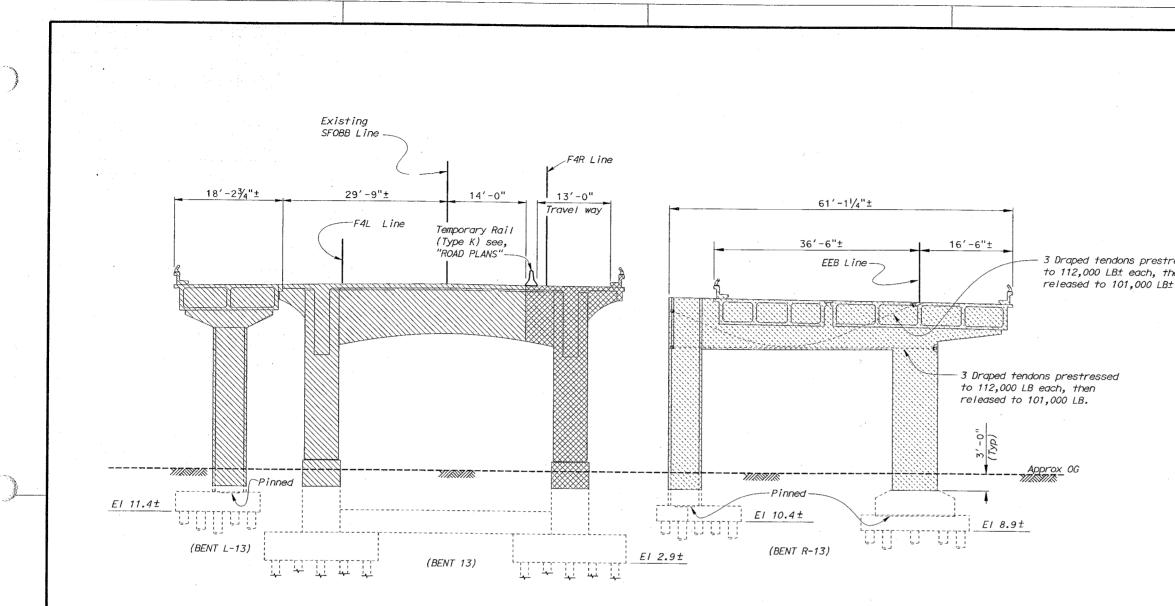DESIGN

DETAILS

QUANTITIES

Notes:

скер J. Zhang

HECKED J. Zhang

K. Bhala

ORIGINAL SCALE IN INCHES

1. All piles not shown. Bent 15 not on piles.

2. Bent 13 shown, Bents 14, & 15 similar.

3. For bent locations and details not shown, see

"Demolition Layout Plan No. 2 and No. 3" sheets.

NOTE; THE CONTRACTOR SHALL VERIFY ALL CONTROLLING FIELD DIMENSIONS BEFORE ORDERING OR FABRICATING ANY MATERIAL.

STRUCTURES DESIGN DETAIL SHEET (ENGLISH) (REV. 1/1/99)


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-	DEPARTMENT OF TRANSPORTATION	STRUCTURE DESIGN 2	POST MILE 5.07/5.67	DEN

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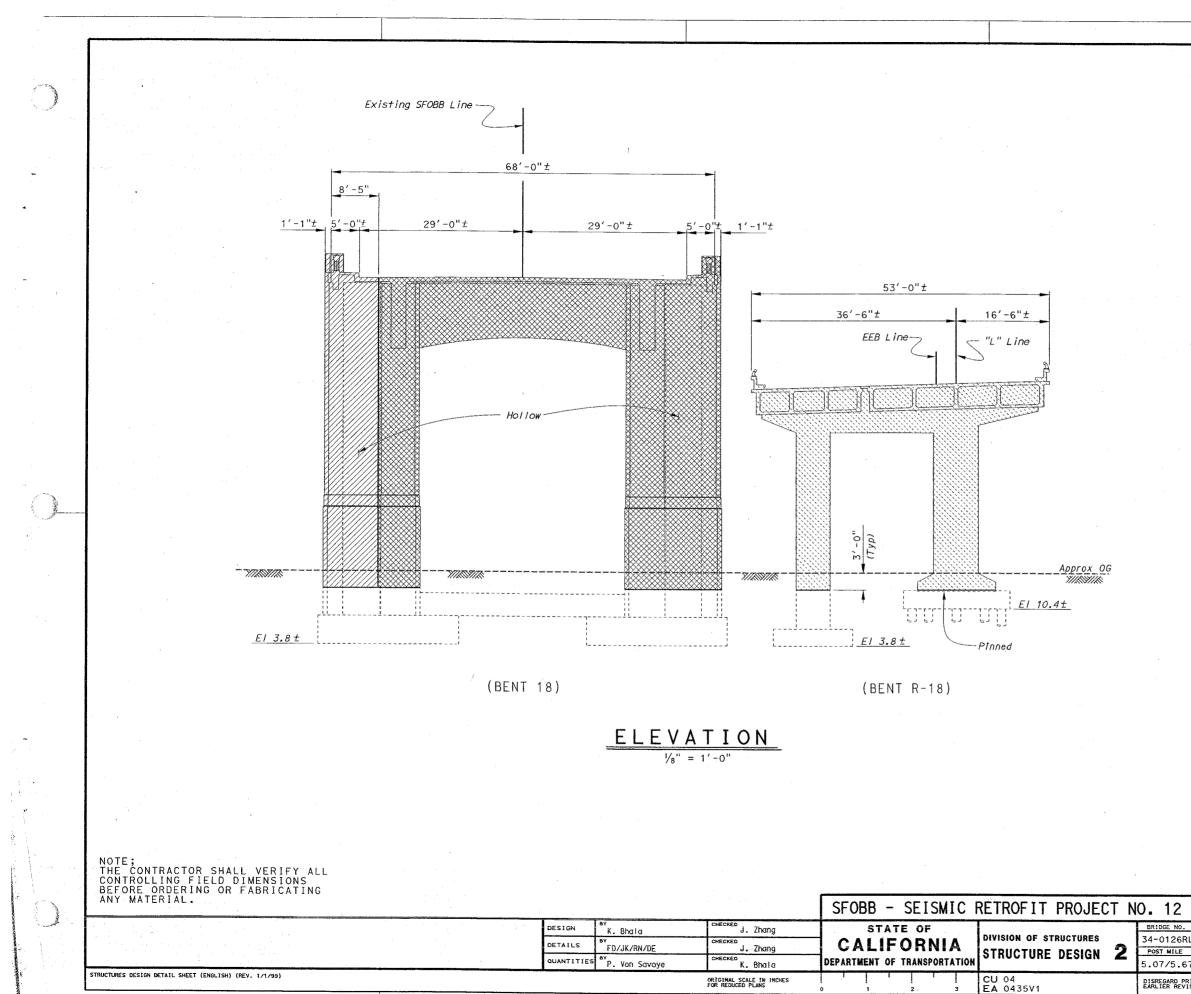
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ELEVATION 1/8" = 1'-0"

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<u> </u>	Indicate	es Demolo	ation Lim	its			
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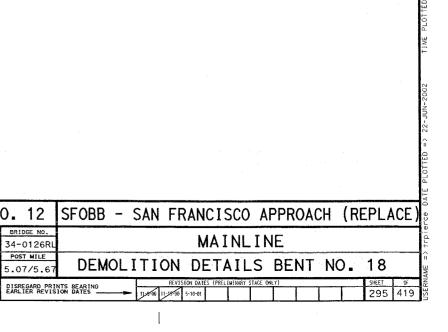
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The State of California or its officers or agents $*_{S_{2}}$ CIVIL shall not be responsible for the accuracy or completeness of electronic copies of this plan sheet.										
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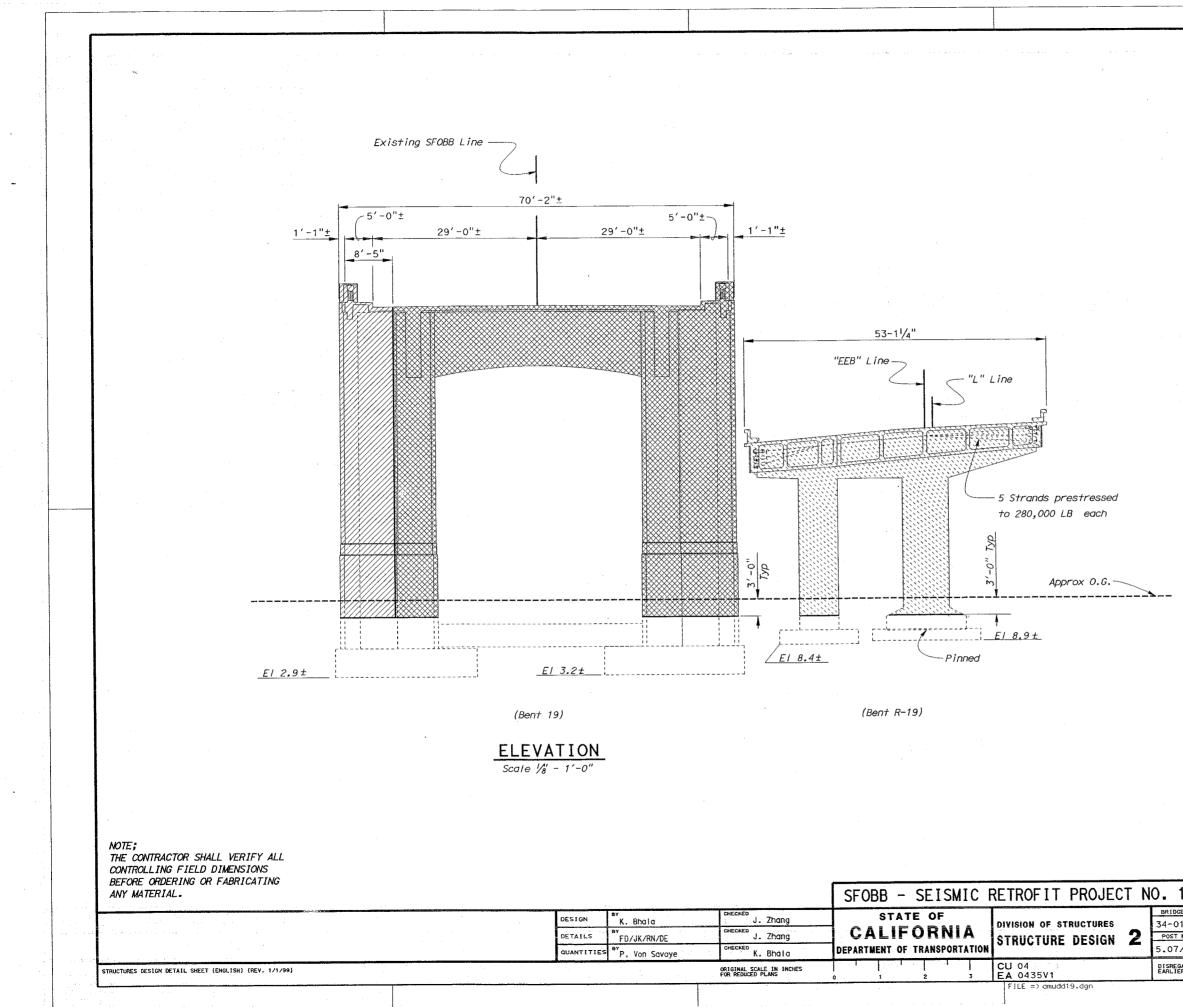
LEGEND

 Indicates Demolation Limits
Indicates Limits of Stage 1 Bridge Removal
Indicates Limits of Stage 3 Bridge Removal
Indicates Limits of Stage 5 Bridge Removal

Notes:

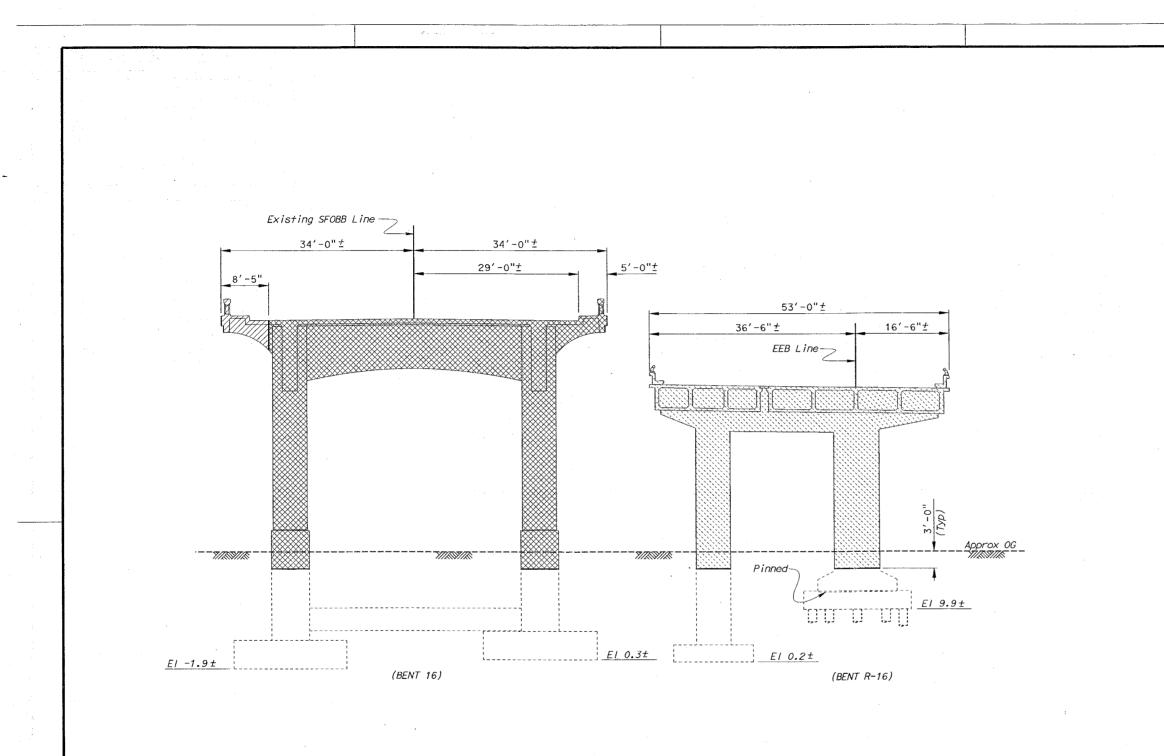- I. All piles not shown.
- 2. For bent locations and details not shown, see "Demolition Layout Plan No. 3" sheet.





DIST	COUNTY	ROUTE	POST MILES TOTAL PROJECT	SHEET No	TOTAL SHEE TS
04	SF	80	4.9/5.9	1177	1511
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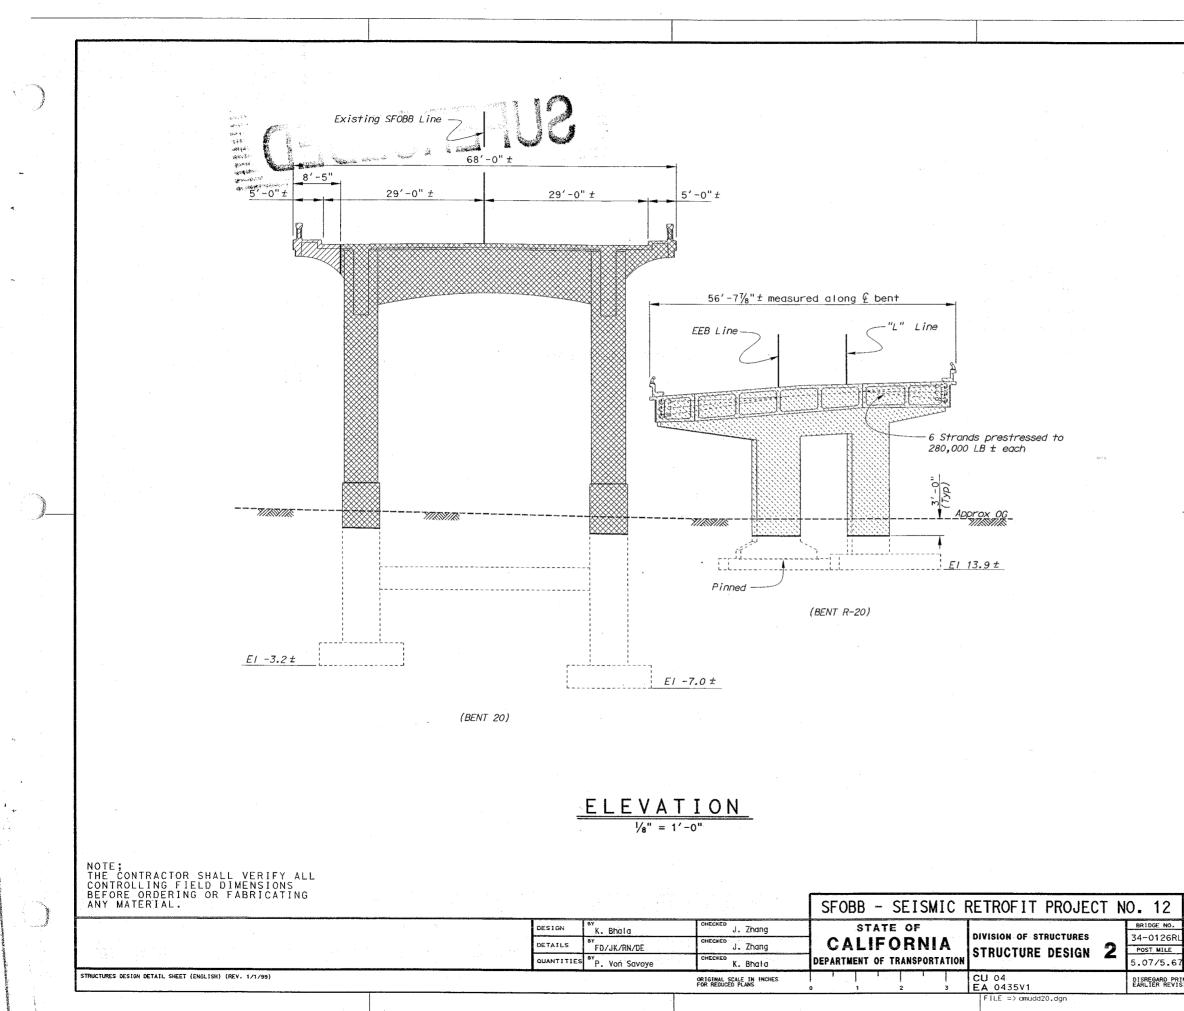
LEGEND

	Indicates Demolation Limits
	Indicates Limits of Stage 1 Bridge Removal
	Indicates Limits of Stage 3 Bridge Removal
<u> </u>	Indicates Limits of Stage 5 Bridge Removal

Note:

1. For bent locations and details not shown, see "Demolition Layout Plan No. 3" sheet.

12	SFOBB - S	SAN FRA	NCISCO	APP	ROACH	(RE	PLA	CE)
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MILE /5.67	DEMOL	ITION	DETAI	LS I	BENT	NO	. 1	9
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DIST	COUNTY	ROUTE	POST MILES TOTAL PROJECT	SHEE T No	TOTAL SHEETS	
04	SF	80	4.9/5.9	1178	1511	
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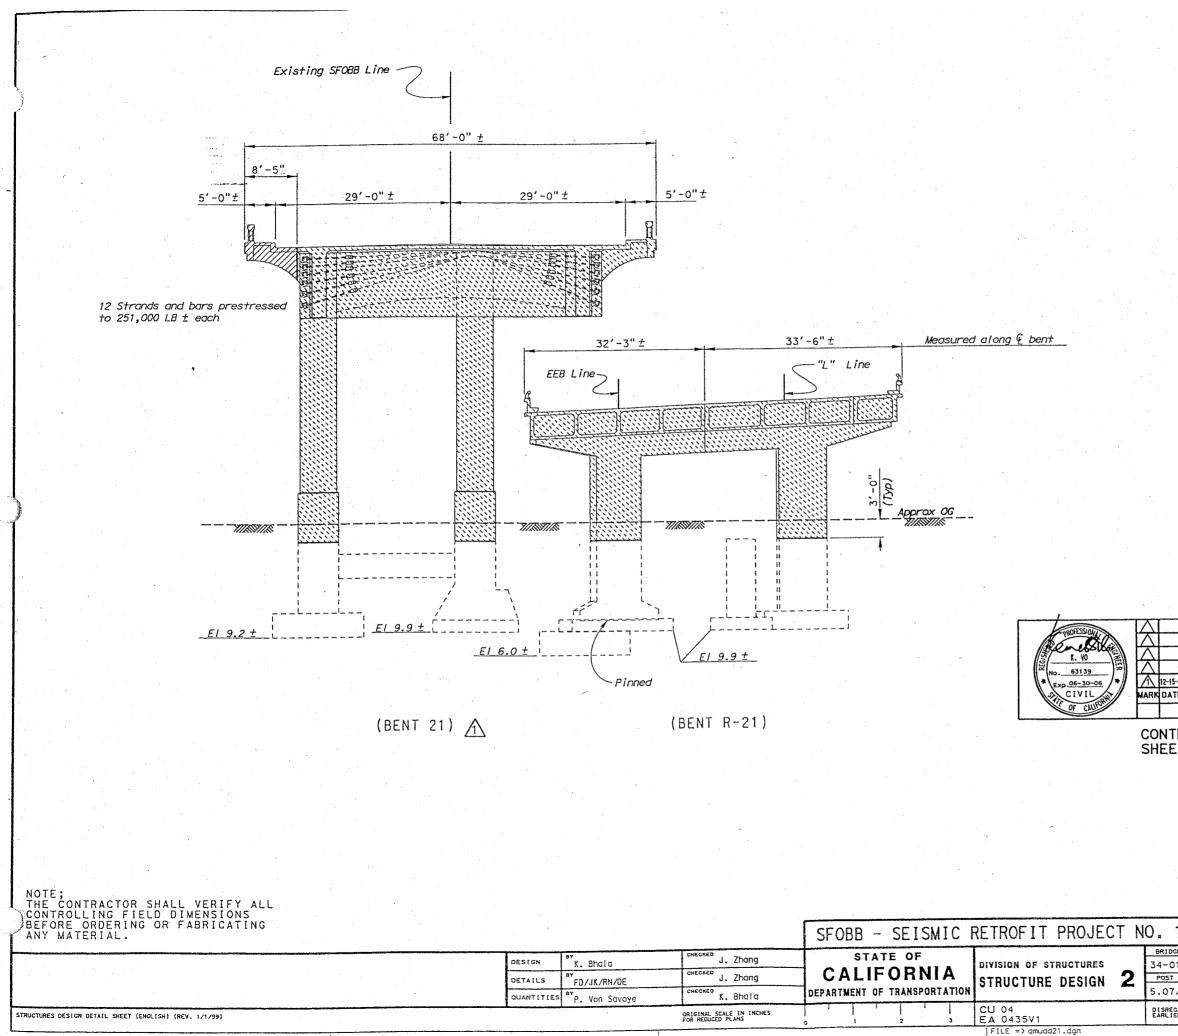
LEGEND

 Indicates Demolation Limits
 Indicates Limits of Stage 1 Bridge Removal
 Indicates Limits of Stage 3 Bridge Removal
 Indicates Limits of Stage 5 Bridge Removal

Notes:

1. For bent locations and details not shown, see "Demolition Layout Plan No. 3" sheet.

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The State of California or its officers or agents shall not be responsible for the accuracy or completeness of electronic copies of this plan sheet.								
Caltrans now has a web site! To get to the web site, go to: http://www.dot.ca.gov								

LEGEND

Indicates	Demolition	Limits



Indicates Limits of Stage | Bridge Removal



Indicates Limits of Stage 5 Bridge Removal


Notes:


- 1. All piles not shown.
- 2. For bent locations and details not shown, see "Demolition Layout Plan No. 3", "Demolition Layout Plan No. 4" and "Demolition Layout Plan No. 5" sheets.


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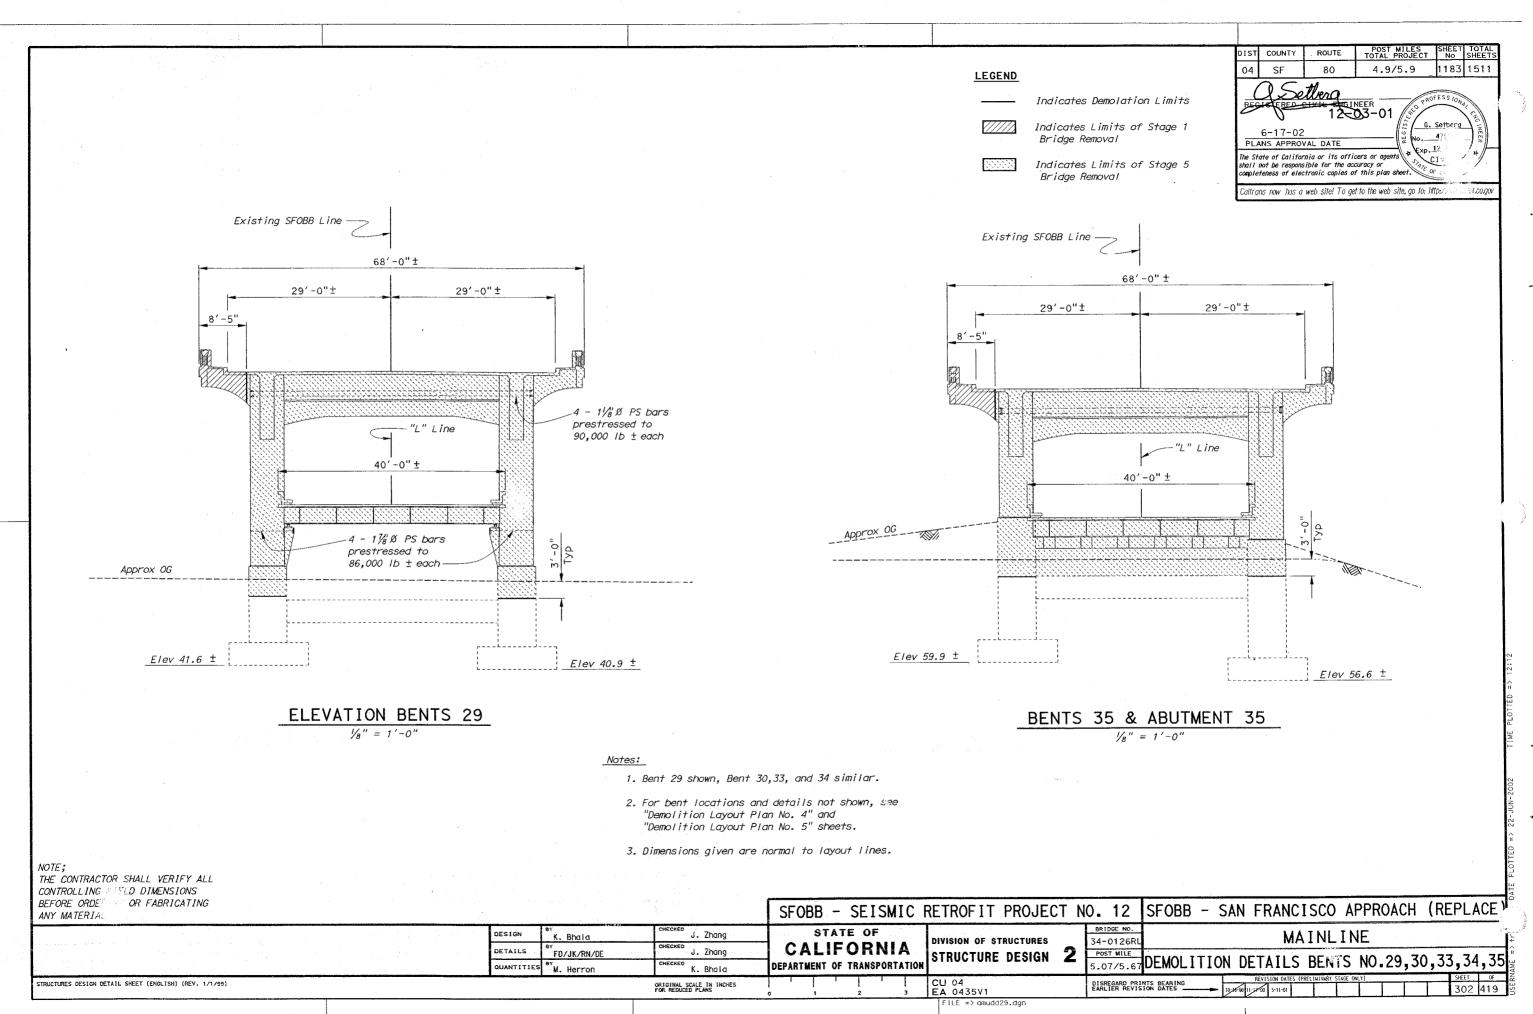
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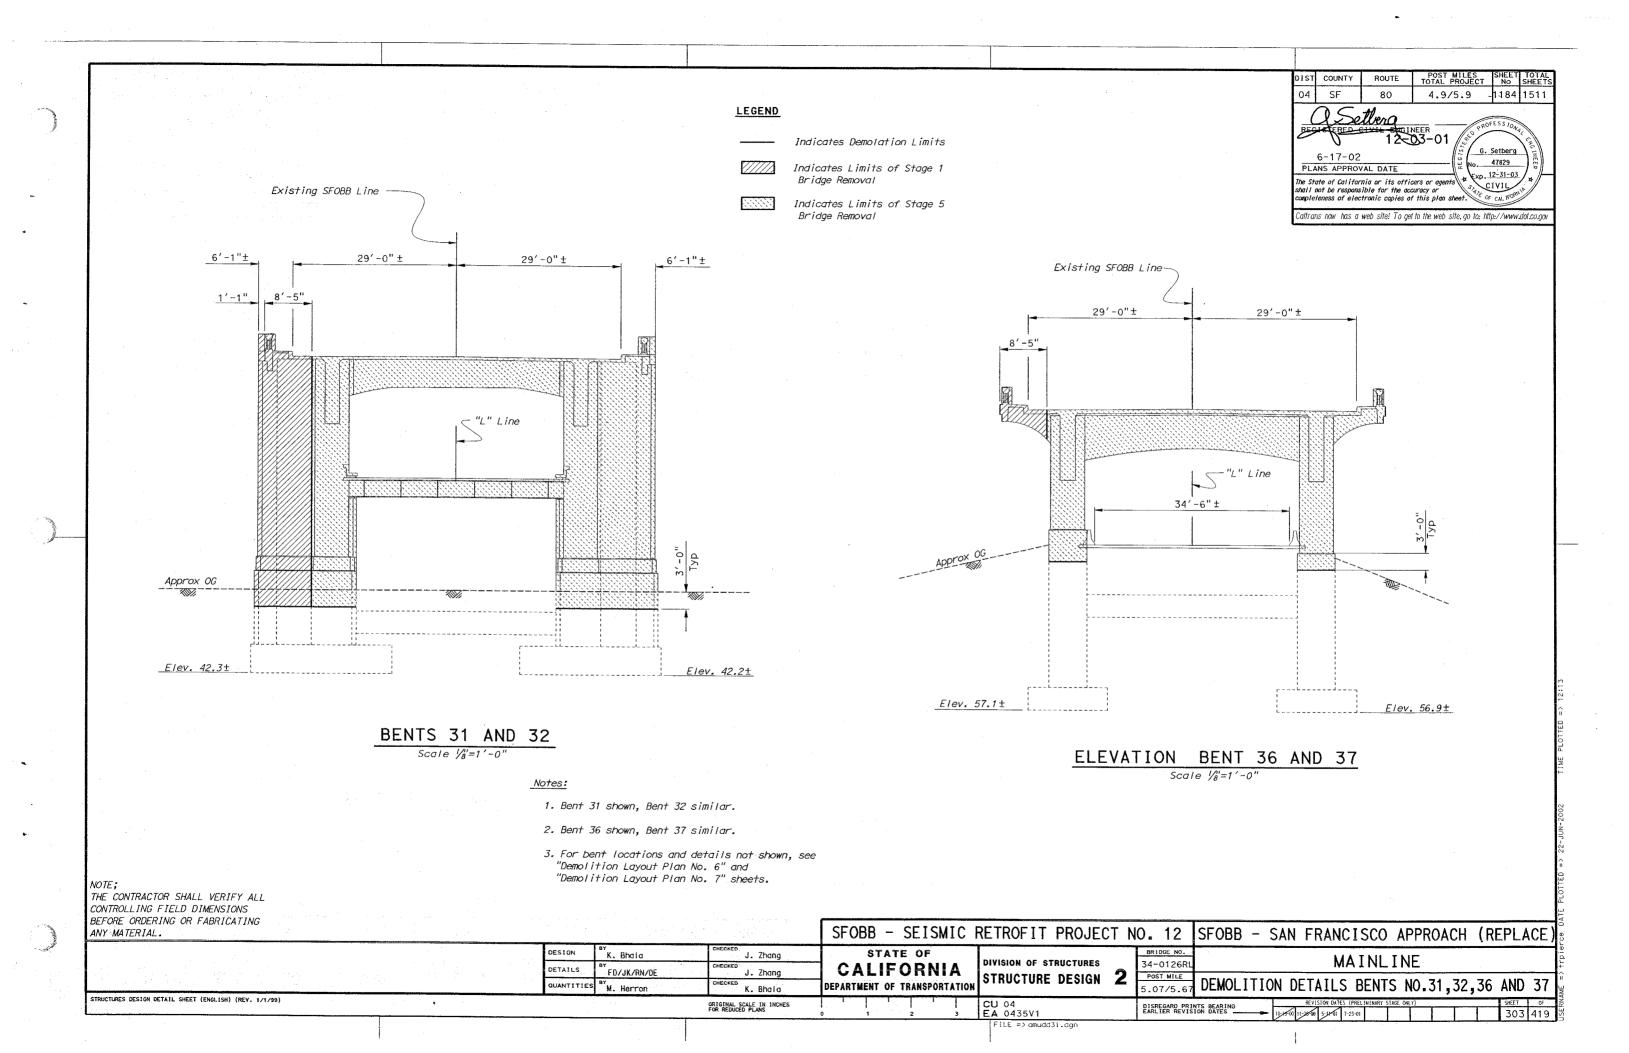
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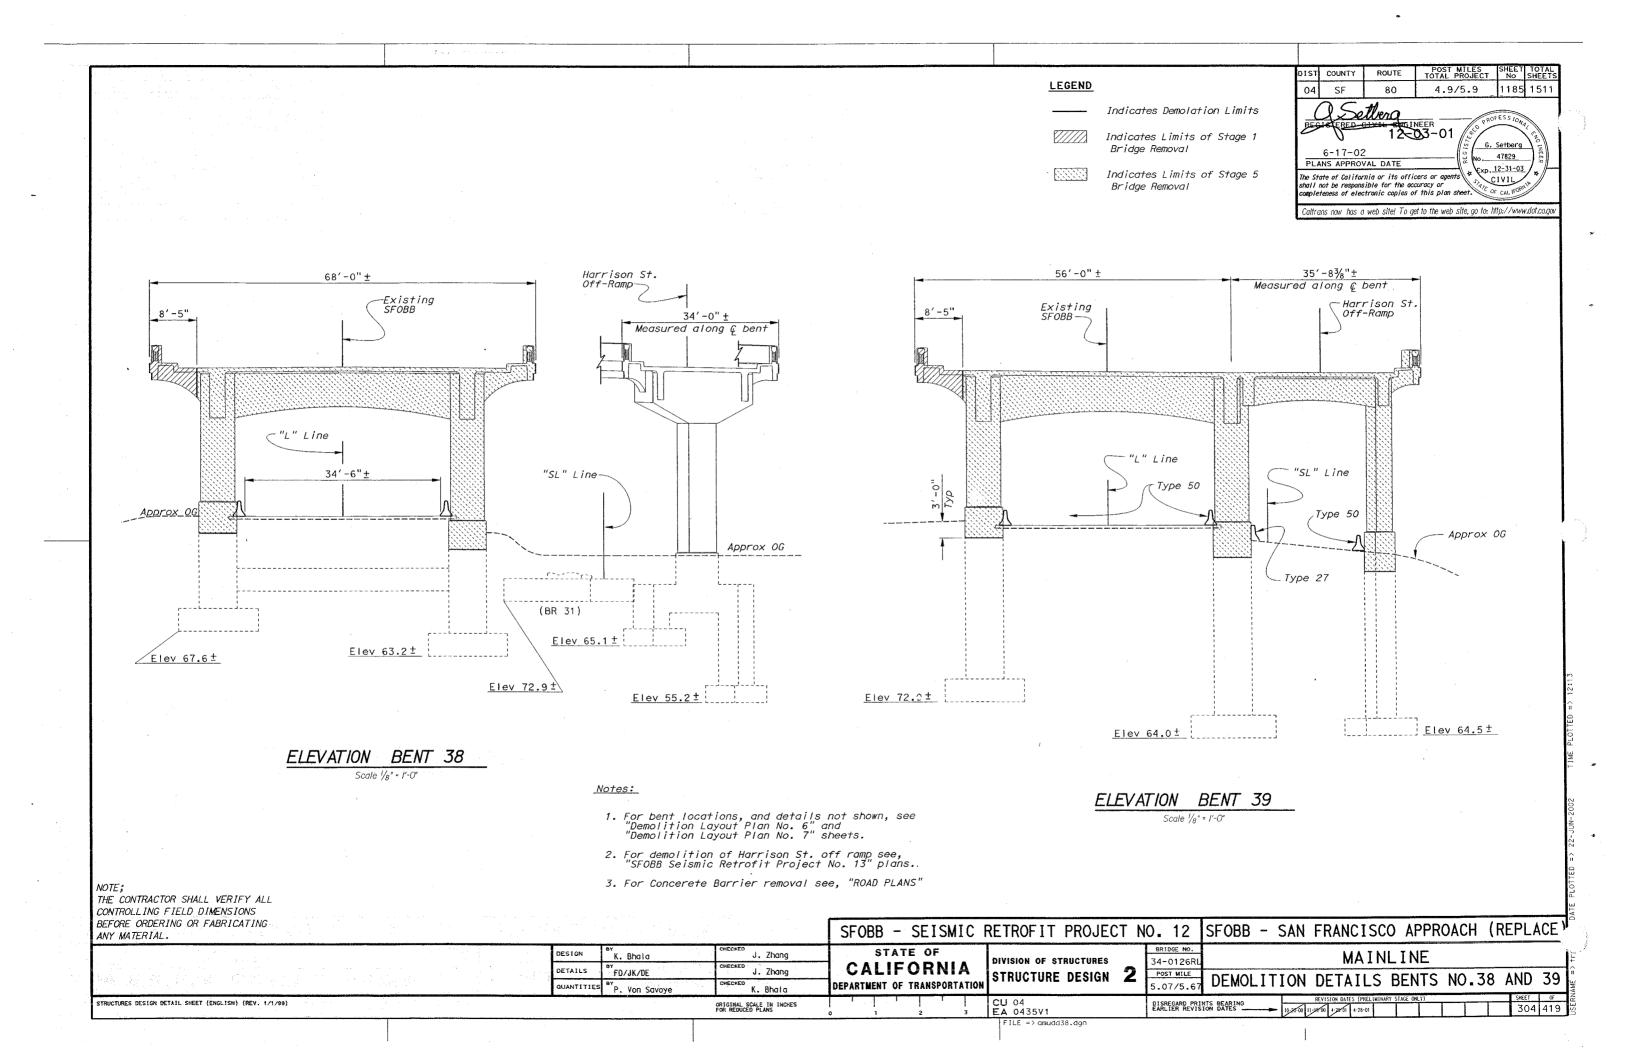







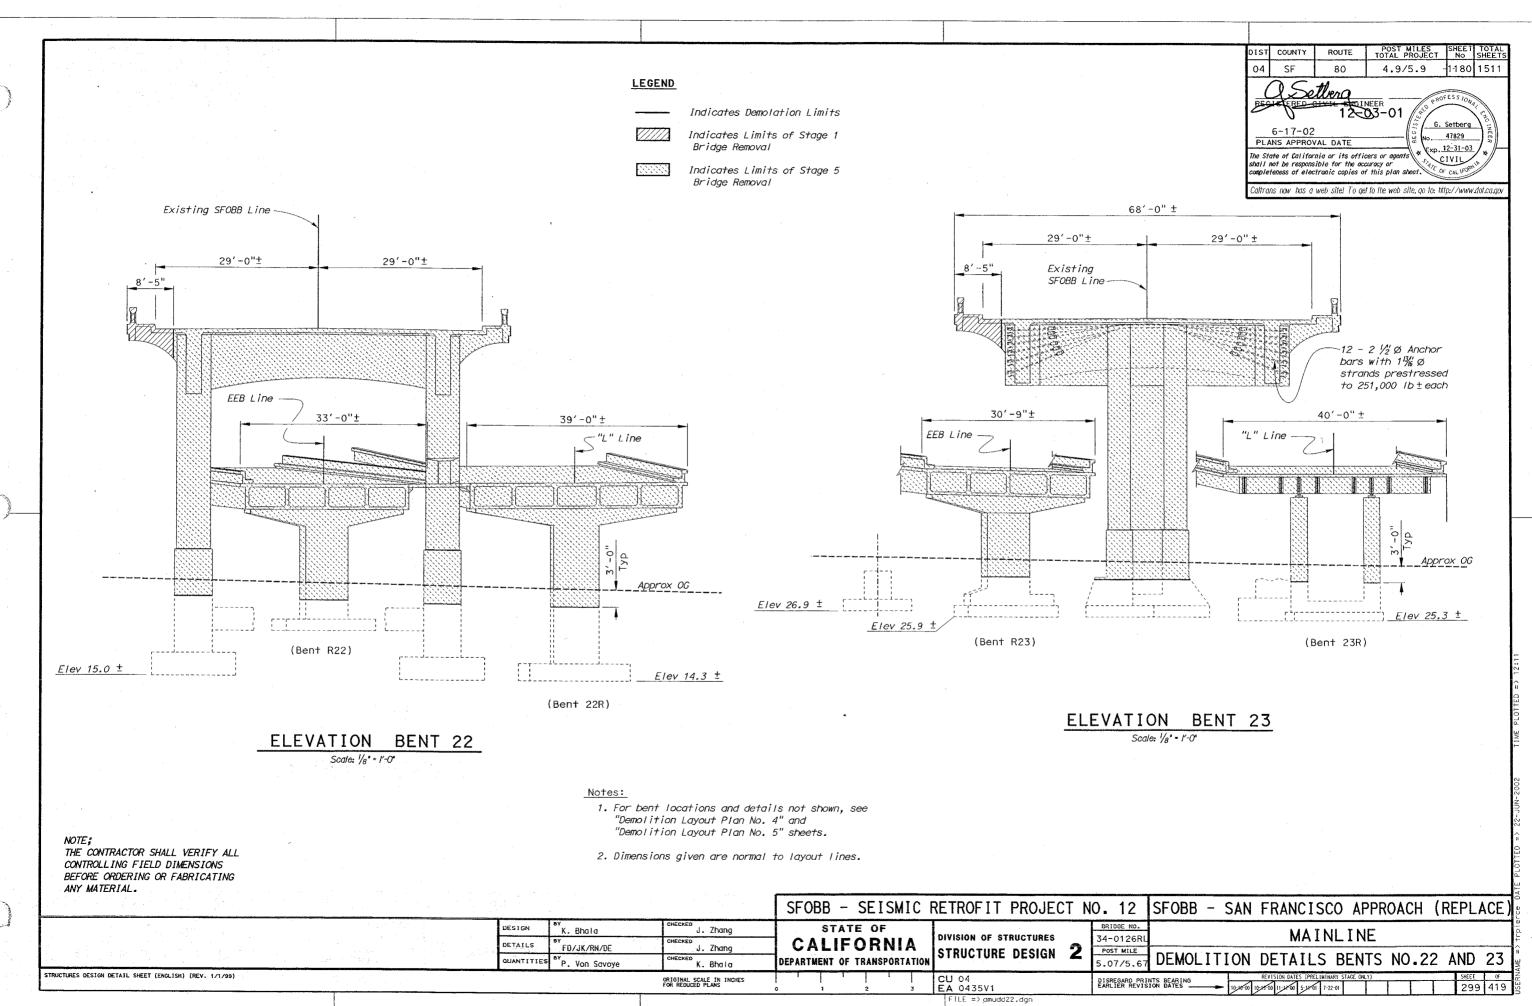

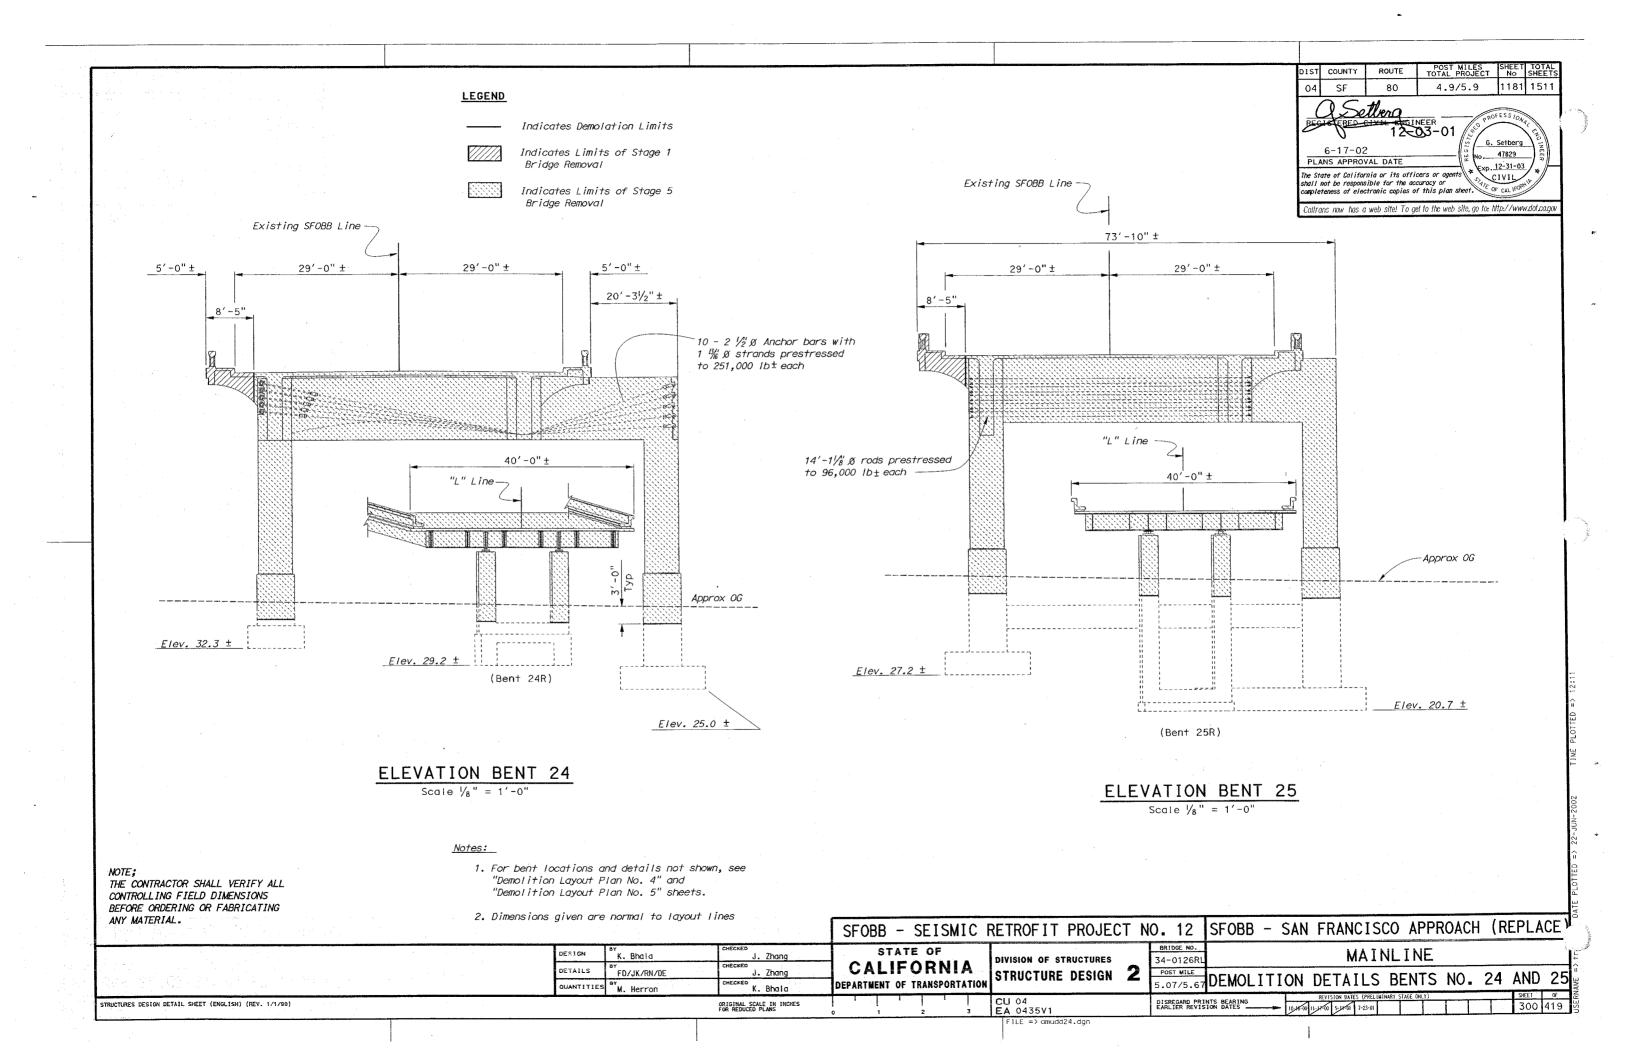

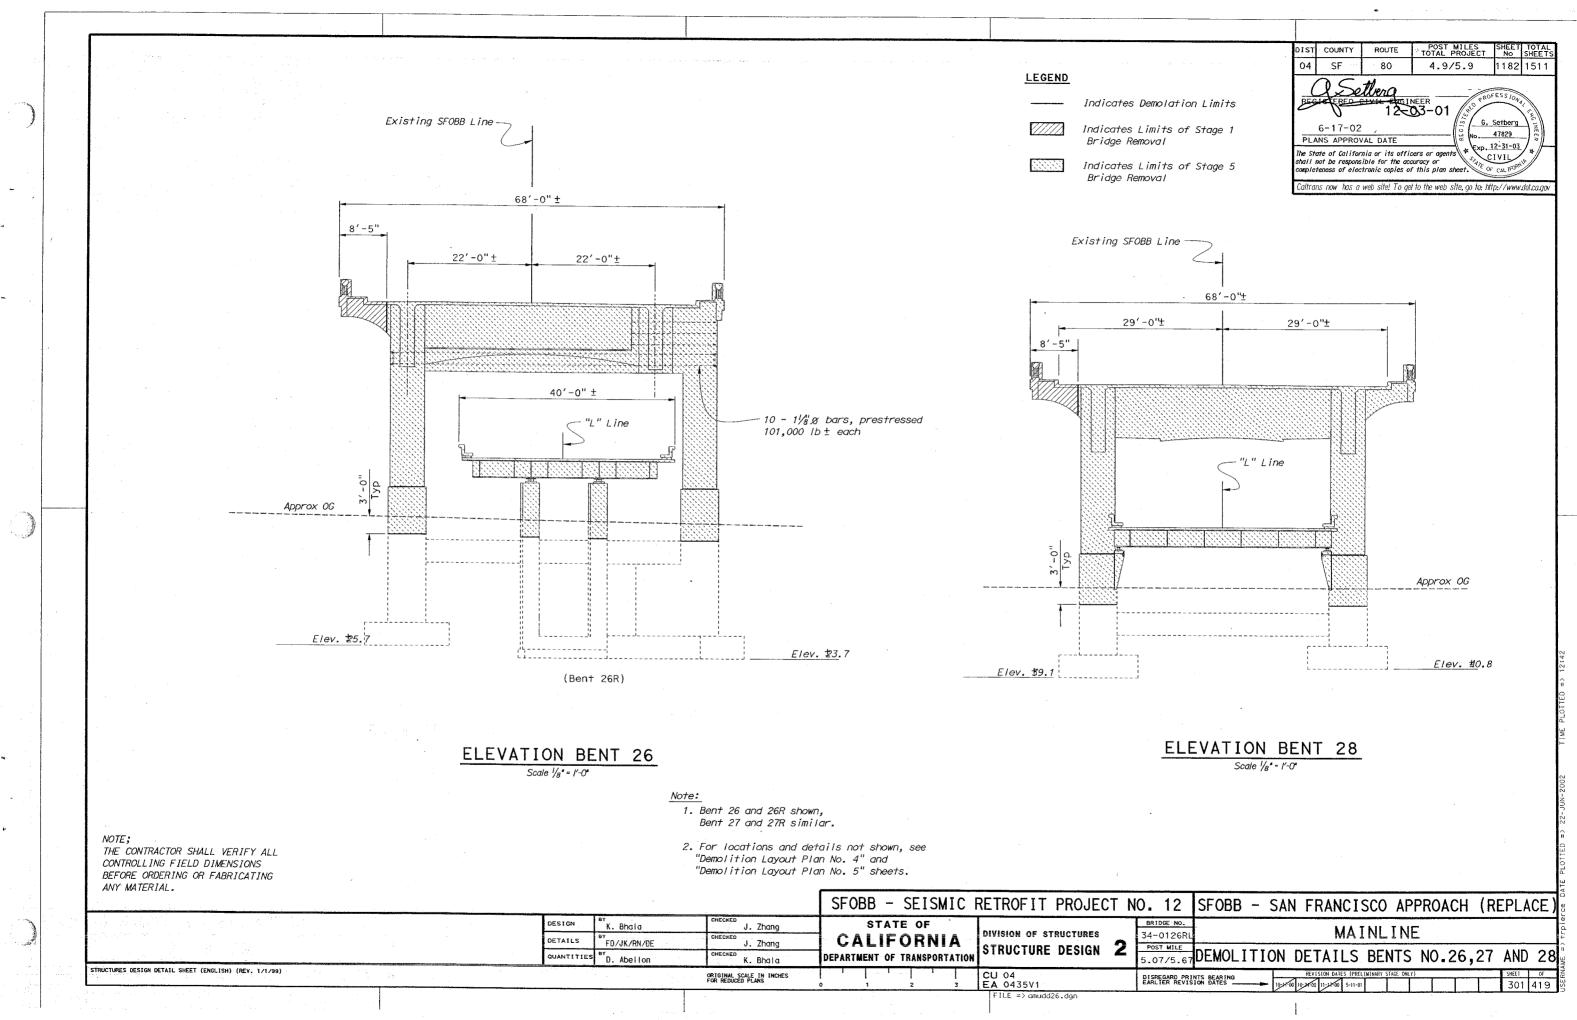

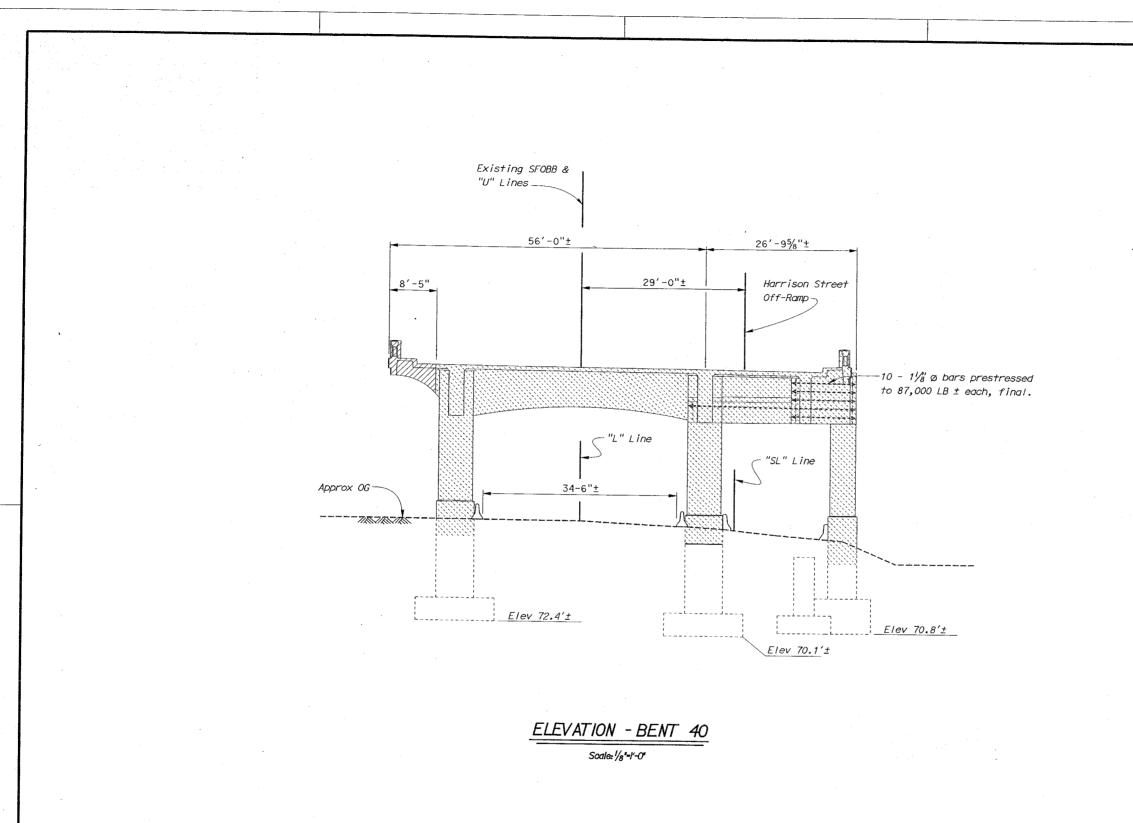


NOTE: THE CONTRACTOR SHALL VERIFY ALL CONTROLLING FIELD DIMENSIONS BEFORE ORDERING OR FABRICATING ANY MATERIAL

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SFOBB - SEISMIC RETROFIT PROJECT NO. 12 DESIGN STATE OF K. Bhala BRIDGE NO. J. Zhang CHECKED J. Zhang DIVISION OF STRUCTURES CALIFORNIA 34-0126RI DETAILS JK/FD/MH/DE STRUCTURE DESIGN 2POST MILE CHECKED K. Bhala QUANTITIES N. Herron DEPARTMENT OF TRANSPORTATION 5.07/5.67 STRUCTURES DESIGN DETAIL SHEET (ENGLISH) (REV. 1/1/99) ORIGINAL SCALE IN INCHES FOR REDUCED PLANS CU 04 EA 0435V1 DISREGARD PRINTS FILE => cmudd40.dgn

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ELEVATION - BENT 41 Scale:1/8"=1'-0"

			SFOBB - SEISMIC	RETROFIT PROJECT N	NO. 12
	DESIGN BY K. Bhaia DETAILS BY JK/FD/MH/DE QUANTITIES BY M. Herron	CHECKED J. Zhang CHECKED J. Zhang CHECKED K. Bhala	STATE OF CALIFORNIA DEPARTMENT OF TRANSPORTATION	DIVISION OF STRUCTURES	BRIDGE NO. 34-0126RL POST MILE 5.07/5.67
STRUCTURES DESIGN DETAIL SHEET (ENGLISH) (REV. 1/1/99)		ORIGINAL SCALE IN INCHES FOR REDUCED PLANS		CU 04 EA 0435V1 FILE => gmudd41.dgn	DISREGARD PRINT EARLIER REVISIO
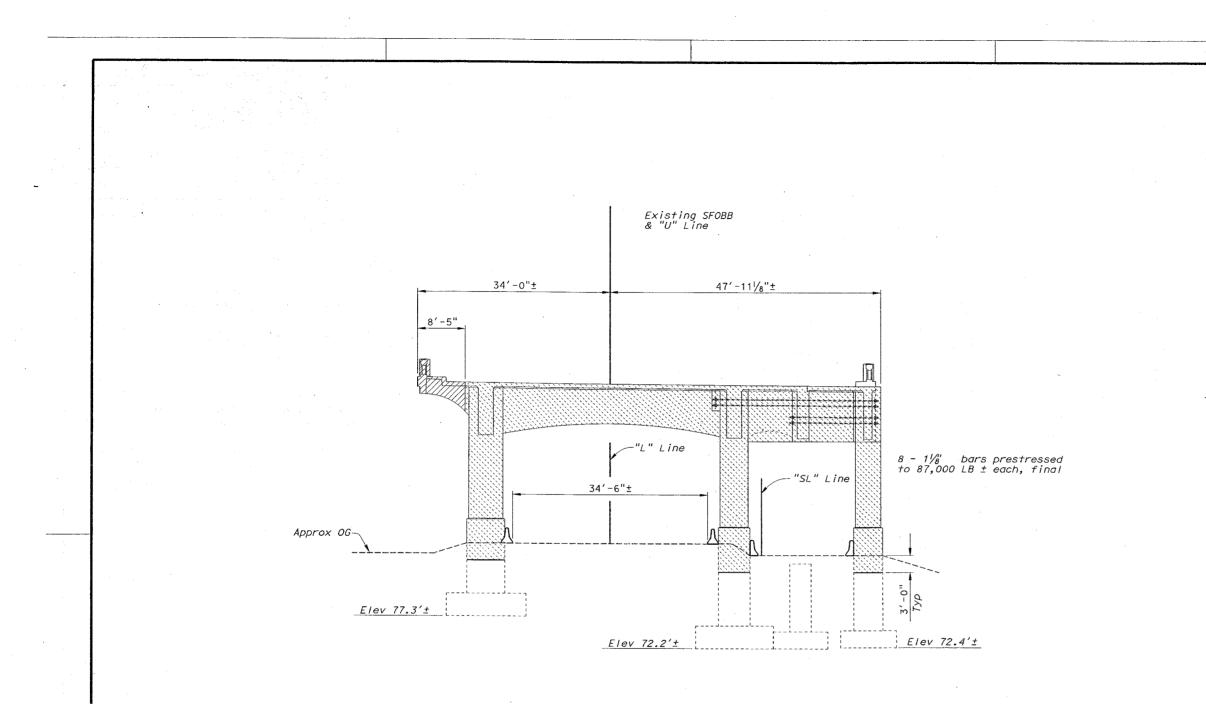
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LEGEND


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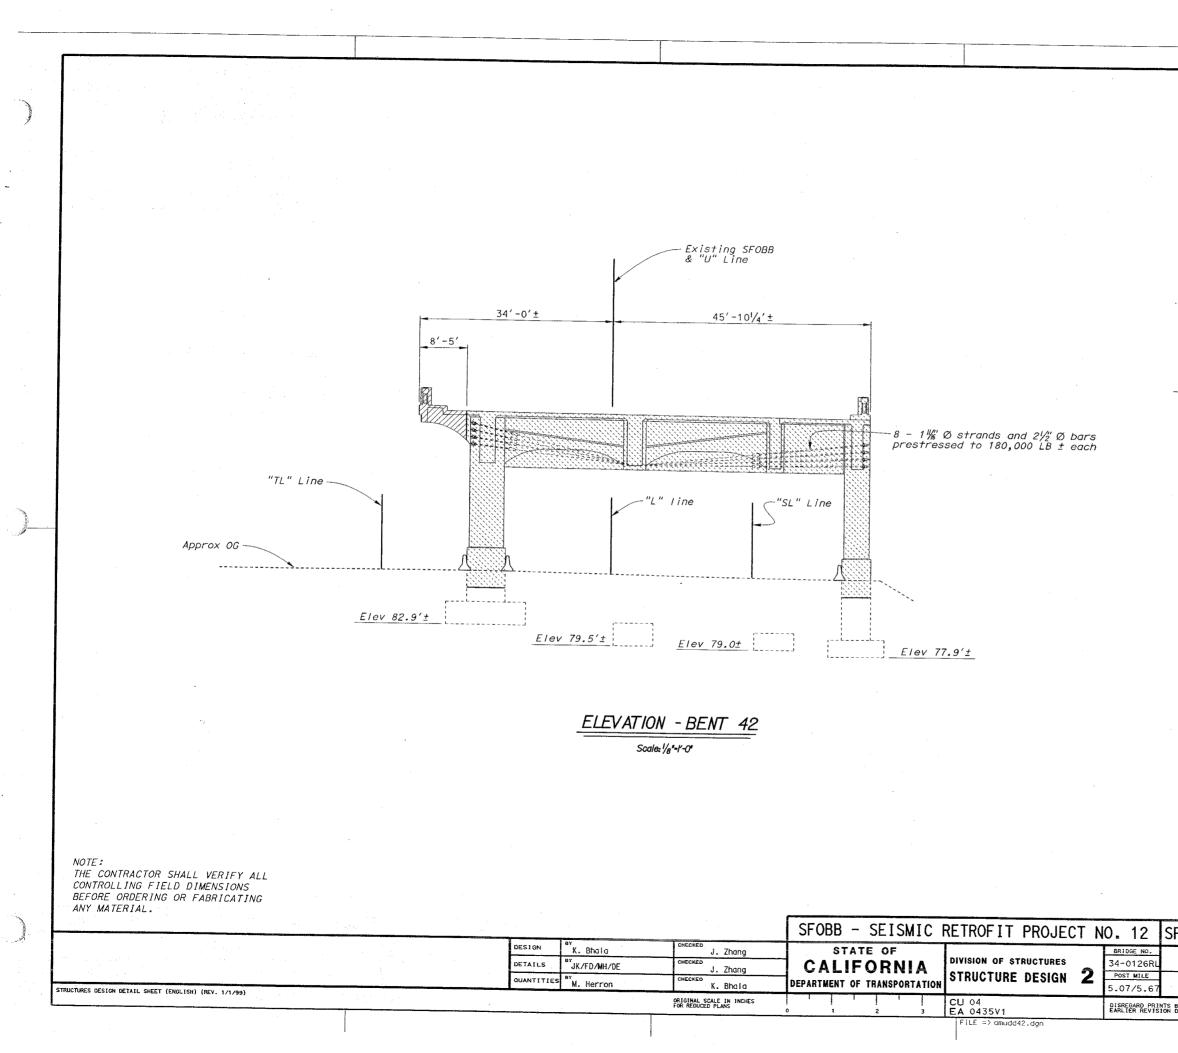
Limits of Stage 1 Bridge Removal

Limits of Stage 5 Bridge Removal


Notes:

- For bent locations and details not shown, see "Demoiltion Layout Plan No. 8" sheet.
- 2. For concrete barrier removal see "ROAD PLANS".




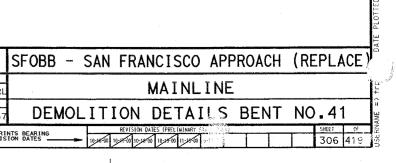

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	L	imits c	of Stage	2 Bridge Remo	oval	
	L	imits c	of Stage	5 Bridge Remo	oval	
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2. For detail "Demolitio "Interim S	s no n La	t showr yout Pl rt - Be	n, see 'an No. 8	" and		
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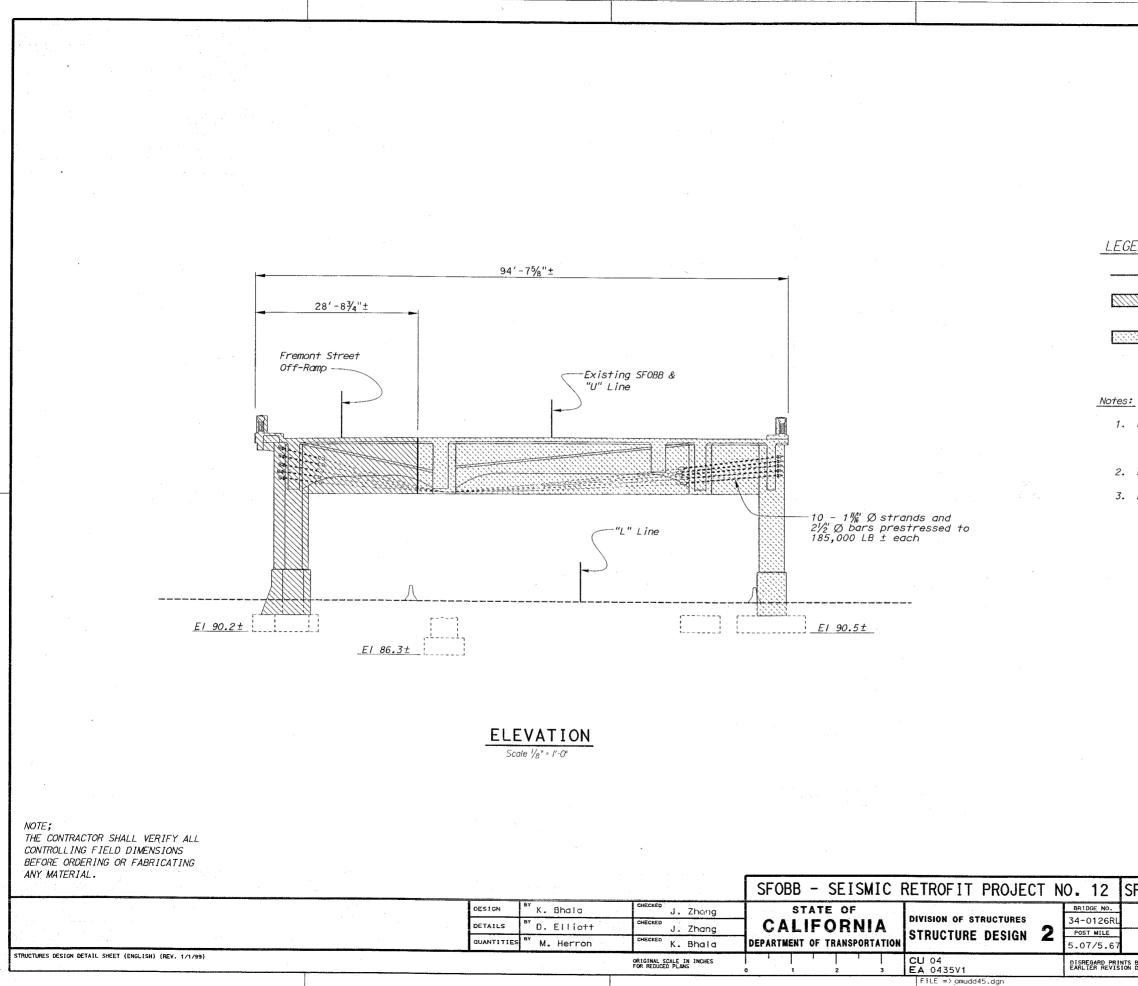
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The State of California or its officers or agents shall not be responsible for the accuracy or completeness of electronic copies of this plan sheet.							
Caltrar	s now has a	web site! To ae	t to the web site, go to: htt	n.//www	dot ca orv		

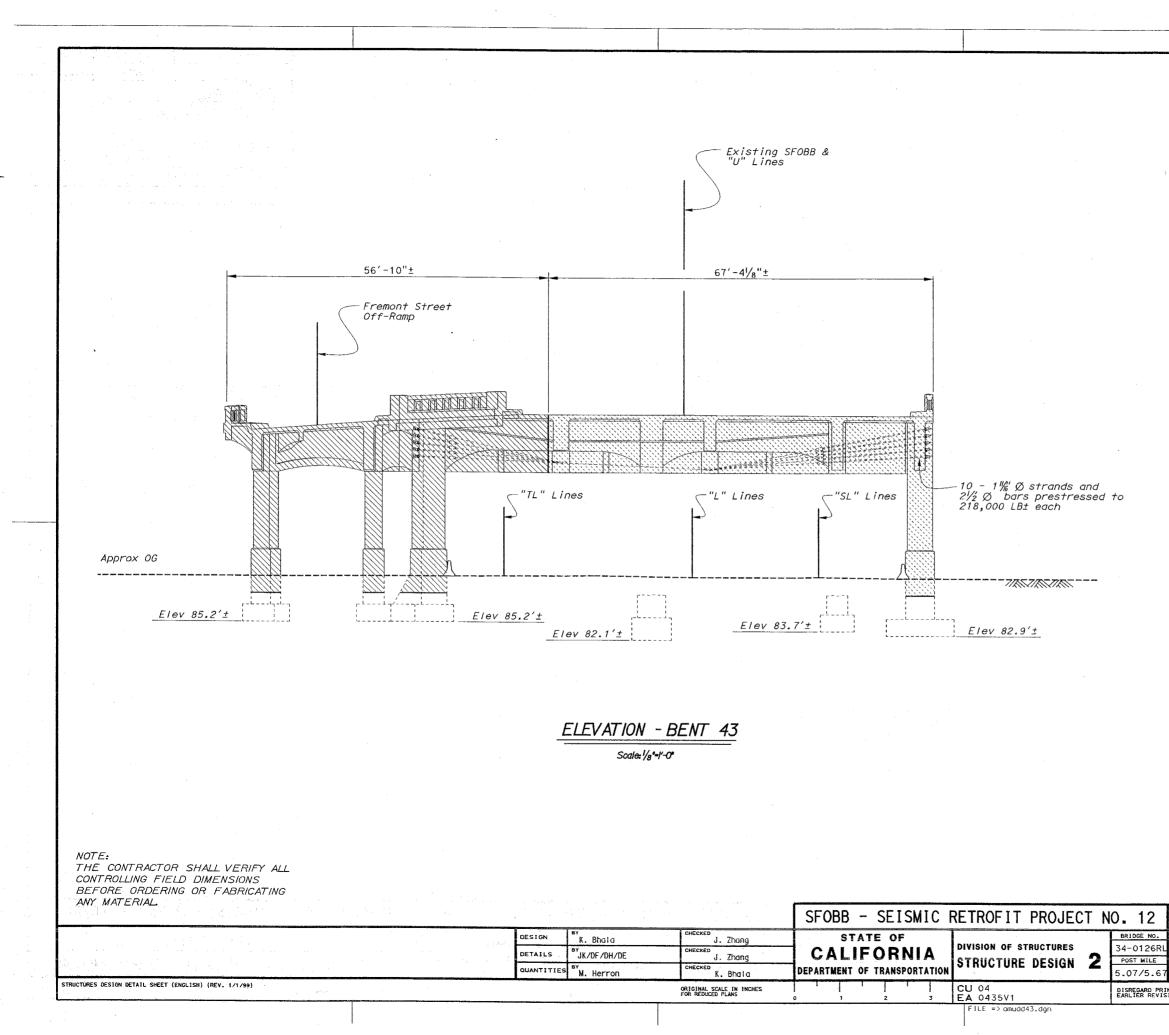Limits of Stage 2 Bridge Removal Limits of Stage 5 Bridge Removal

1. For bent locations and details not shown, see "Demolition Layout Plan No. 8" and "Interim Support - Bent 44" sheets.

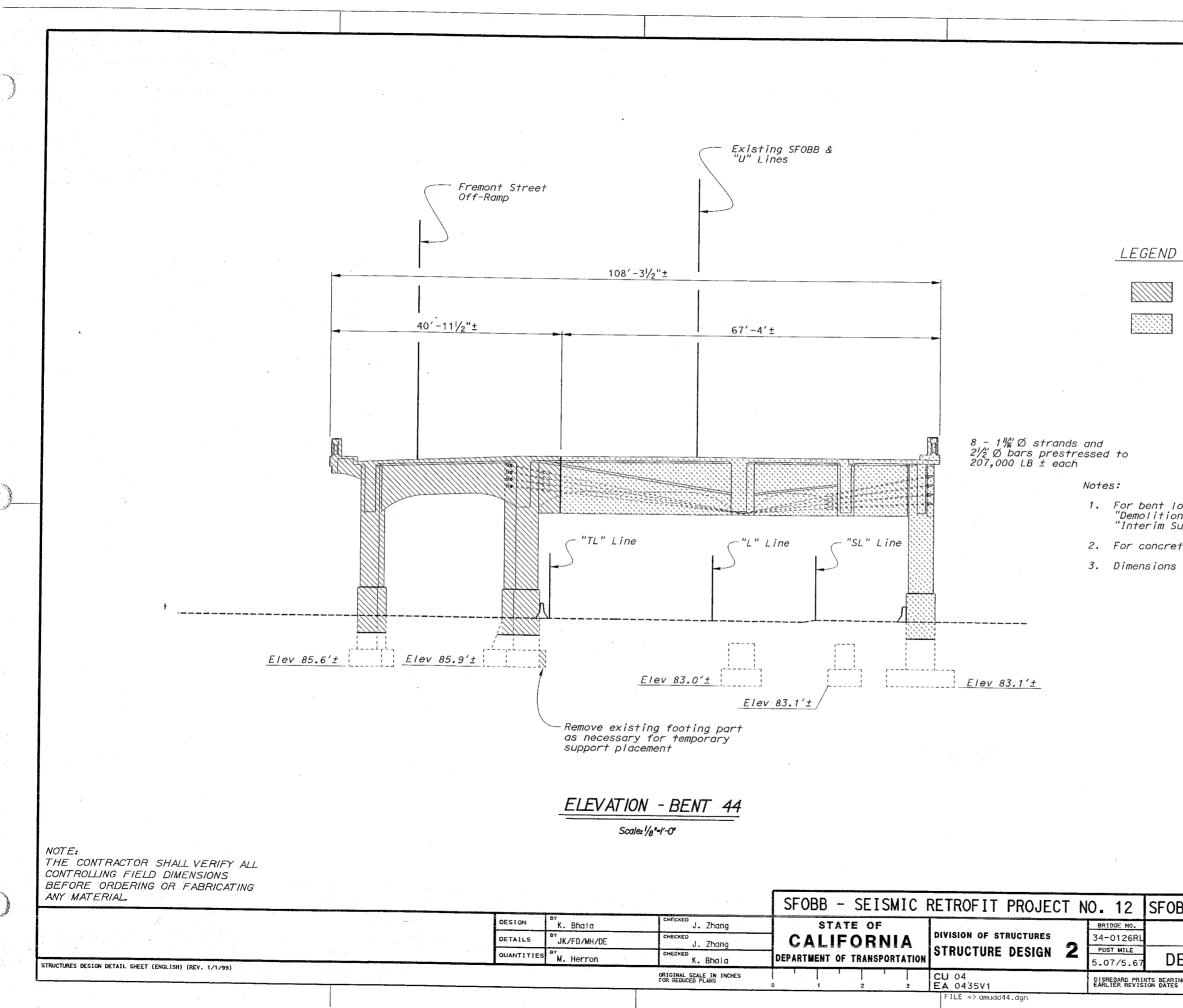2. For concrete barrier removal, see "ROAD PLANS". 3. Dimensions shown normal to existing SFOBB Line.

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E E E E E E E E E E E E E E E E E E E
PLOTTED => 22-JUN-2002
SFOBB - SAN FRANCISCO APPROACH (REPLACE)
DEMOLITION DETAILS BENT NO.44
BEARING REVISION DATES (PRELIMINARY STAGE ONLY) SHEET OF N DATES 19:45:00 10:45:00 11:45:00 12:45:00 30.9 41.9 55



DIST	COUNTY	ROUTE	POST MILES TOTAL PROJECT	SHEET No	TOTAL SHEETS				
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The State of California or its officers or agents * (CIVIL shall not be responsible for the occuracy or completeness of electronic copies of this plan sheet.									
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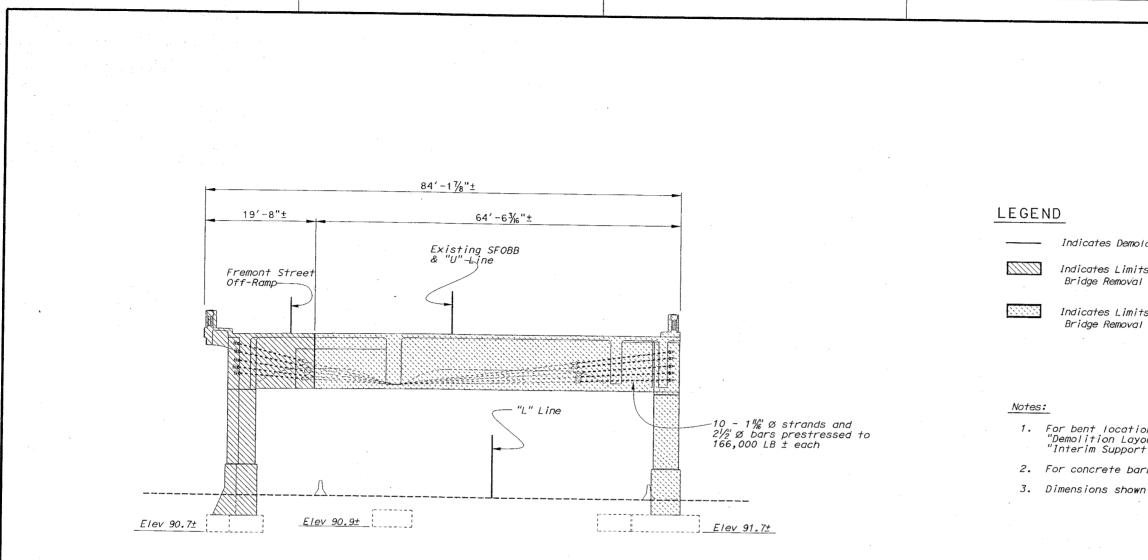
LEGEND

 Indicates	Demolation	Limits

- Indicates Limits of Stage 2 Bridge Removal
- Indicates Limits of Stage 5 Sec. 1 Bridge Removal

- 1. For bent locations and details not shown, see "Demolition Layout Plan No. 8" and "Interim Support- Bent 45" sheets.
- 2. For concrete barrier removal see, "ROAD PLANS".
- 3. Dimensions shown normal to existing SFOBB line.

	SFOBB -	SAN FRAI	VCISCO	APP	ROACI	H (RE	EPL/	ACE)	DATE P
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ELEVATION Scale 1/8"= 1"-0"

NOTE; THE CONTRACTOR SHALL VERIFY ALL CONTROLLING FIELD DIMENSIONS BEFORE ORDERING OR FABRICATING ANY MATERIAL.

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	DETAILS D. Elliott	J. Zhang	CALIFORNIA	DIVISION OF STRUCTURES	34-0126RL
	 QUANTITIES BY M. Herron	CHECKED K. Bhala	DEPARTMENT OF TRANSPORTATION	ISTRUCTURE REGION 7	POST MILE 5.07/5.67
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Indicates Demolation Limits


Indicates Limits of Stage 2

Indicates Limits of Stage 5 Bridge Removal

For bent locations and details not shown, see "Demolition Layout Plan No. 8" and "Interim Support - Bent 46" sheets.

2. For concrete barrier removal see, "ROAD PLANS". 3. Dimensions shown normal to existing SFOBB line.

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Indicates Demolation Limits

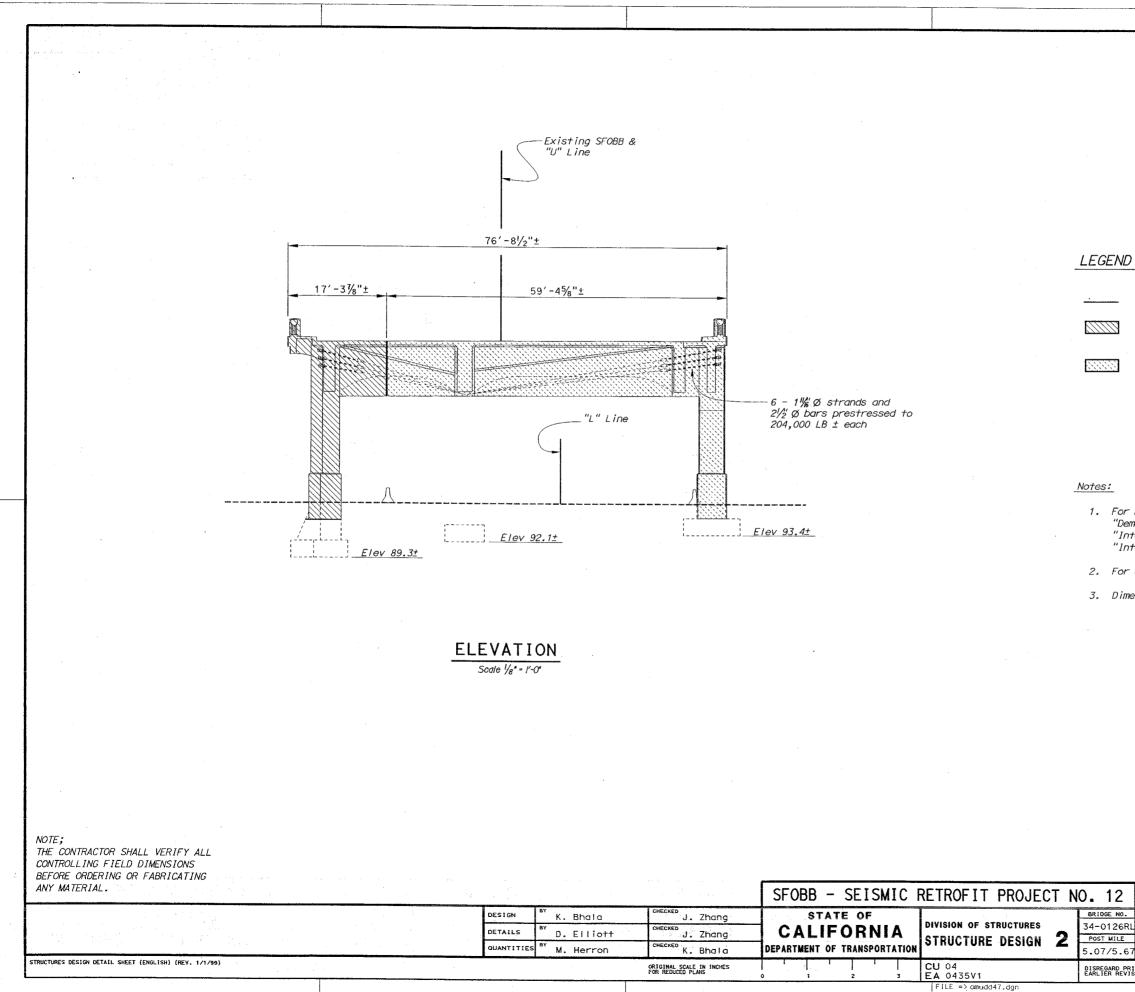Indicates Limits of Stage 2 Bridge Removal


Indicates Limits of Stage 5 Bridge Removal

 For bent locations and details not shown, see "Demolition Layout Plan No. 8", "Interim Support - Bent 48" and "Interim Support - Bent 49" sheets.

2. For concrete barrier removal see, "ROAD PLANS".

3. Dimensions shown normal to existing SFOBB line.

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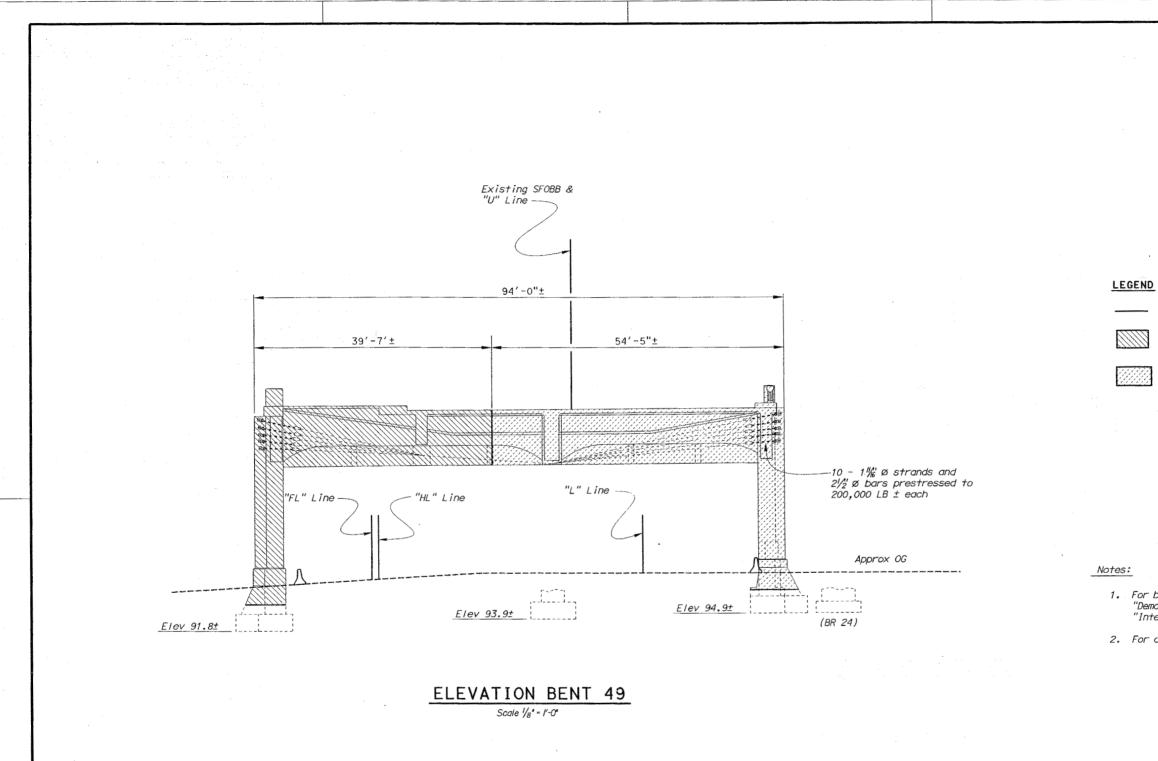
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NOTE; THE CONTRACTOR SHALL VERIFY ALL CONTROLLING FIELD DIMENSIONS					
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	DESIGN BY K. Bhala	J. Zhang	STATE OF	DIVISION OF STRUCTURES	BRIDGE NO. 34-0126RL
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Indicates Demolation Limits

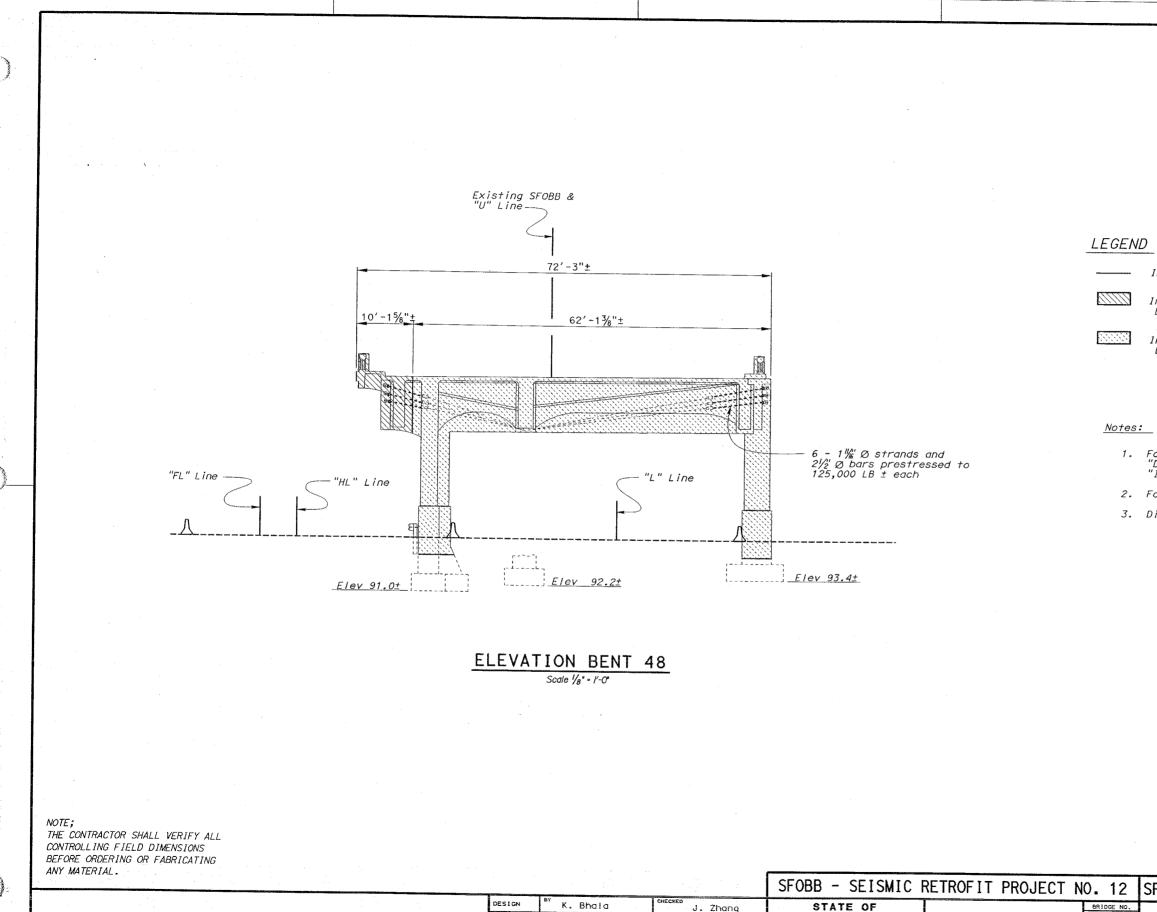Indicates Limits of Stage 2 Bridge Removal Indicates Limits of Stage 4 Bridge Removal

For bent locations and details not shown, see "Demolition Layout Plan No. 8" and "Interim Support - Bent 49" sheets.

2. For concrete barrier removal see, "ROAD PLANS".

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BUS STORAGE FACILITY (Contract 17-05-BSF-000)

Questions are numbered in the order received. Questions 1–20 are included in a previously issued response set, which was posted to the TJPA's website at http://transbaycenter.org/rfp/bus-storage-facility on February 7, 2017.

Question No.	Submission Date	Drawing No.	Document/ Spec. No.	Question	Response
21	2.7.17		13 34 19	The bid spec calls for CBC 2013; that code is no longer valid. The code is CBC 2016. Modular builders will not build to the City and County of San Francisco Code. California has a state program under the Department of Housing and Community Dev. Even if a modular manufacture was willing to build to a City code there would be no inspection process to validate it; the state won't inspect to the city's code and the city won't inspect at a factory outside of their jurisdiction. Can you look into their concerns and revise the specifications if required?	The manufacturing of the proposed Modular Units will be regulated and governed by the California Department of Housing and Community Development (HCD). The references to 2013 CBC and its associated standards remain where applicable.
22	2.7.17	A-3001, A-3004, A-3010	13 34 19	The spec provided in the bid docs (Section 13 34 19 – Commercial Modular Building Systems) is NOT applicable to the project based on what is shown on	manufacturers will include Williams Scotsman, Mobile Modular, ModSpace (formerly GE Capital) or equally qualified vendors.
23	2.7.17	C-1001, C-1002		On plan Sheets C-1001 and C-1002, it says to remove existing buried foundations as needed. Is it safe to assume that the foundations have been removed to at least 3' below existing grade, as is Caltrans' current standard procedure? If not, can you reference which plan sheets, either from the bid set or the one or more appended Caltrans construction drawings that show the as-built elevations to which the piers were removed?	previously issued response set.

Question No.	Submission Date	Drawing No.	Document/ Spec. No.	Question	Response
24	2.8.17	C-1001, C-1002		Please see attached bid drawings C-1001 and C-1002. Please confirm should the highlighted existing foundations require demolition, the existing foundations must be demolished 3' below new final grade.	The existing foundations have been demolished 3' below the existing grade. They will need to be further demolished/ removed if the finished grade will be below the elevation to which the foundations were previously demolished. See also the response to question #15 in the previously issued response set.
25	2.8.17	C-2001, C-2002		Please see attached bid drawings Sheet C-2001 and C- 2002, highlighted note states "2" AC overlay (E) soil to remain". During Demo and excavation for flat work, is it acceptable to excavate around columns and round casings, install the retaining and stacked blocked walls, then backfill soil after completion of the referenced walls. Should the soil need to remain against the casings and columns, temp shoring would be required.	existing column casings as per the plans.

BUS STORAGE FACILITY (Contract 17-05-BSF-000)

Questions are numbered in the order received. Questions 1–25 are included in previously issued response sets, which were posted to the TJPA's website at <u>http://transbaycenter.org/rfp/bus-storage-facility</u>. Numbers missing in the sequence will be included in a future answer set.

Question No.	Submission Date	Drawing No.	Document/ Spec. No.	Question	Response
26	2.9.17		Paragraph 2.1.A	Fire alarm system description shows components need to be compatible to operate as an extension of the EST system. EST is a manufacturer of the fire alarm components, but has several models to choose from. Which system will be the main control system of these additional components?	The main control system in the Transbay Transit Center will be an EST3 model.
27	2.10.17		-22, Paragraph 6a	The warranty period for workmanship/defects, etc. appears to be limited to 1 year after completion. However, there is a 1 year warranty for non- conforming work related to surface improvements (pavement, curbs, sidewalks, etc.) and a 2 year warranty for non-conforming Subsurface work (foundations, sewers, side sewers, etc.). Please confirm that this is an accurate requirement of the contract as additional charges will apply if certain portions of the work are covered by 2 year warranties.	Confirmed. Please refer to individual specification sections for supplemental warranty requirements.
29	2.14.17			Addendum 1A and 1B	There has been only one Addendum No.1 issued during the Invitation for Bid (IFB) phase; the other Addendum No. 1 referred to was issued during the Request for Qualifications (RFQ) phase of the procurement. Therefore, for bidding this project, Addendum No. 1 to Bidding Documents, dated February 10, 2017, forms a part of the Contract Documents and modifies the original Bidding Documents dated October 31, 2016. An acknowledgment of receipt of Addendum No. 1, and any future addenda, on the Acknowledgment of Receipt of Addenda form (Section 00 04 32) is required.
30	2.14.17			Please provide part numbers for all door hardware, including all electrified components.	See Door Schedule on Sheet A-9010, Note #3. Refer to Hardware Set Grouping located on Sheet A-9011. Door Number locations can be found on Sheets A-3001, A-3002, and A-1032, Note 25.
31	2.16.17	A-8009, Details 6, 4 & 2	13 34 19	On sheet A-8009, section detail 6, 4 & 2 ask for 5/8" RIP x GWB. What does RIP stand for?	The RIP designation is incorrect. Use Type X GWB in lieu of RIP GWB.

Question No.	Submission Date	Drawing No.	Document/ Spec. No.	Question	Response
32	2.17.17	S-1003		period for retaining walls. Does this apply to Abut 1 and 6 as well?	Confirmed. Please refer to Specification Section 31 00 06 paragraph 3.14 for required settlement periods for retaining walls, Abutment 1 and Abutment 6.
33	2.17.17	S-1065	13 48 43	bearings with comparable performance to the specified lead-rubber bearings?	Any proposed revisions to the specified bearings would need to meet or exceed the performance of the specified bearings and would require approval from Caltrans. Please refer to Specification Section 00 04 20 for procedures for post-contract-award value engineering proposals.
34	2.17.17			We are a second tier contractor looking to bid on the security systems, have prepared the requisite signed NDA forms and list, but CANNOT find an Upload button on the website. We need to get access to these security protected documents and we are losing valuable time trying to get these to you. Can you please advise where to send these NDAs so we can get the documents?	The website upload button for NDA forms was temporarily disabled and is now back in place.
35	2.17.17		00 04 10	storage provided by the owner or MUNI?	The OCS components consist of two OCS conductor cables currently attached to the underside of the eastbound Bay Bridge approach. These will need to be temporarily removed and stored by the Contractor to enable installation of temporary falsework for the bus link ramp. The Contractor will need to re-install the OCS wires upon removal of falsework.
36	2.17.17			oversight?	Yes, Caltrans will have an oversight role because the project is located within the State Right of Way. Resident Engineer services will be provided by a TJPA representative.

BUS STORAGE FACILITY (Contract 17-05-BSF-000)

Questions are numbered in the order received. Questions 1–27 and 29–36 are included in previously issued response sets, which were posted to the TJPA's website at <u>http://transbaycenter.org/rfp/bus-storage-facility</u>.

Question No.	Submission Date	Drawing No.	Document/ Spec. No.	Question	Response
28	2.14.17		00 07 00, 6.06.C	This section refers to mark-up for overhead and profit for "subcontractors, lower tier subcontractors or supplier." It does not specify mark-up for "contractor"?	 Paragraph 6.06.C will be revised as follows: 1. For Work performed by Contractor, the markup shall equal a maximum of 15 percent of its direct costs, as defined herein. 2. For Work performed by a Subcontractor, the markup shall equal a maximum of 15 percent of its direct costs, as defined herein. Contractor shall receive a maximum 5 percent markup on the Subcontractor's total cost. 3. For Work performed by a Lower-Tier Subcontractor or Supplier, the markup shall equal a maximum of 15 percent of its direct costs, as defined herein. Contractor and Subcontractor shall each receive a 5 percent markup on the total cost of their respective Lower-Tier Subcontractors. 4. In no case shall the sum of the individual markups applied to a Change Order exceed 25 percent, regardless of the number of Subcontractor tiers involved in performing the Work.
37	2.17.17	A-8010, Detail 3		 There is no specification for the precast concrete shown on 3/A-8010. Please provide. Sheet S-2025 shows a Stage 1 and Stage 2 work. What does "Install temporary sound wall mean?" I cannot find anything in the construction documents that addresses this. 	 Precast Concrete Sill – MODCON (or equal) manufactures a variety of sill profiles including the sill profile shown in detail 3/ detail 3/A- 8010. Chapter 5 of the Transbay Terminal Final Environmental Impact Statement/ Environmental Impact Report (FEIS/EIR) includes mitigation requirements including noise mitigation item NoiO3 for noise walls prior to the start of construction. Plan sheet S-2025 shows a temporary sound wall in order to comply with this requirement. The FEIS/EIR can be downloaded from the TJPA site at <u>http://transbaycenter.org/documents/final-eiseir</u>

Question No.	Submission Date	Drawing No.	Document/ Spec. No.	Question	Response
				have the CMU as being split faced and provides the field and accent colors. Will sheet A-6011 be revised to reflect this and will split faced units also be required on the interior walls? 4) Details 6 and 8 on A-9013 show chamfered corners on the masonry. Is that the intent?	 3) Addendum 1 addresses the CMU used on the perimeter wall. Sheet A-5002 and Detail A-6011 refer to a fluted block and ground face block. The fluted block will be oriented to the sides of the building in the public view and of the same block color as the ground face block. No revisions to the Storage Building elevations and wall sections are required. Interior CMU walls orientated to the inside of the building will be ground face block surfaces. 4) Chamfered block is not required.